- COMPLETE EXTENT OF EXISTING SPRINKLER PIPING NOT SHOWN. CONTRACTOR TO FIELD VERIFY EXTENT OF PIPING. CONTRACTOR TO FIELD CONFIRM AVAILABLE SITE WATER PRESSURE AND FLOW. CONTRACTOR SHALL PROVIDE DESIGN, CALCULATIONS, PERMITS
- 2. MODIFY AND/OR EXTEND EXISTING WET PIPE FIRE SUPPRESSION SYSTEM THROUGHOUT PORTION OF FACILITY INDICATED, TO PROVIDE FULL COVERAGE TO ALL SPACES.IN ACCORDANCE WITH NFPA 13, THE STATE OF MAINE FIRE MARSHAL'S OFFICE, AND THE CITY OF SCARBOROUGH, ME
- 3. SPRINKLER PIPING MAINS NOT PERMITTED IN ELECTRICAL ROOMS OR OVER SWITCH GEAR, IN TEL/COM ROOMS OR OVER TEL/COM EQUIPMENT.
- 4. PROVIDE SPRINKLER COVERAGE OVER ALL CABLE TRAYS. COORDINATE WITH ELECTRICAL
- 5. COORDINATE SPRINKLER PIPING LOCATIONS W/
- 6. ALL AREAS CLASSIFIED AS "LIGHT HAZARD"
- 7. IN SPACES WITH GYPSUM OR TILE CEILINGS, PIPING SHALL BE CONCEALED WITH SEMI-RECESSED SPRINKLER HEADS. HEADS SHALL BE LOCATED IN THE
- 8. FULLY CONCEALED SPRINKLER HEADS SHALL BE INSTALLED IN PUBLIC AREAS AS SPECIFIED. COVERS SHALL BE FINISHED TO MATCH ADJACENT CEILING COVER
- 9. EXPOSED PIPING WITH UPRIGHT HEADS IS ACCEPTABLE IN OCCUPIED SPACES W/ EXPOSED
- 10. PIPING SHALL BE STANDARD WEIGHT BLACK-STEEL PIPE CONFORMING WITH ASTM A53 WITH THREADED ENDS AND FITTINGS UP TO 2" NPS. PIPING FOR NPS 2-1/2 AND UP SHALL BE STANDARD-WEIGHT BLACK STEEL PIPE CONFORMING WITH ASTM A53 WITH EITHER THREADED ENDS AND FITTINGS, ROLL-GROOVED ENDS AND COUPLINGS, OR PLAIN ENDS FOR
- 11. ESCUTCHEONS SHALL BE PROVIDED AT EXPOSED PIPING PENETRATIONS THROUGH WALLS. ESCUTCHEONS SHALL HAVE CHROME

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GSA FITOUT 40 MANSON LIBBY ROAD SCARBOROUGH, ME 04074

FIRST FLOOR FIRE PROTECTION PLAN

SHEET TITLE: WBRC CAD FILE: PROJECT No.

As indicated PROJECT MANAGER: DRAWN BY: CHECKED BY:

	PLUN	MBING SYMBOLS		PLUMBING ABI
SYMBOL	ABV.	DESCRIPTION	ABV.	DESCRIPTION
	HW	HOT WATER PIPING	ADA	AMERICANS WITH DISABILITIES ACT
	HWR	HOT WATER RETURN PIPING	A.F.F	ABOVE FINISH FLOOR
	CW	COLD WATER PIPING	CA-1	COMPRESSED AIR CONNECTION
тнw	THW	TEMPERED HOT WATER	CFM	CUBIC FEET PER MINUTE
w	w	SANITARY WASTE PIPING	CH-1	REMOTE CHILLER (ELEC. WATER COOLER)
w	w	UNDER SLAB SANITARY WASTE PIPING	СРА	COMPRESSED AIR EQUIPMENT
	v	VENT PIPING	DIA.	DIAMETER
PW	PW	PUMPED WASTE	DN	DOWN
IW	IW	INDIRECT WASTE	DU	DISTRIBUTION UNIT
CA	CA	COMPRESSED AIR	DW	DISHWASHER
CD	CD	CONDENSATE DRAIN	DWV	DRAINAGE, WASTE, & VENT
IWV	v	INDIRECT WASTE VENT	EE	EMERGENCY EQUIPMENT
	RW	RAINWATER PIPING	EWC	ELECTRIC WATER COOLER
	RW	UNDER SLAB RAINWATER PIPING	EWH	ELECTRIC WATER HEATER
IA	IA	N.G. WATER HEATER INTAKE AIR	FD	FLOOR DRAIN
FA	EA	N.G. WATER HEATER EXHAUST AIR	FT	FEET
— - CH — - —	CH	CHILLED WATER PIPING	GAL.	GALLONS
НТ	нт	HEAT TRACE	GPH	GALLONS PER HOUR
	G	GAS PIPING	GPM	GALLONS PER MINUTE
0		PIPE TURNING UP	GWH	GAS WATER HEATER
G		PIPE TURNING DOWN	HP	HORSE POWER
го ф		FLOOR CLEANOUT	HWR	HOT WATER RECIRCULATION
со I		WALL OR END OF LINE CLEANOUT	HWT	HOT WATER RECIRCULATION HOT WATER TANK
WC-1		PLUMBING FIXTURE NUMBER -	IN	
○ FD		REFER TO PLUMBING FIXTURE SCHEDULE FLOOR DRAIN	IIV	INCHES
RD		ROOF DRAIN		
		SHUT-OFF VALVE	-	
		BALANCING VALVE	-	
		CHECK VALVE	-	
		PIPE CAP	-	
<u> </u>		THERMOMETER	-	
<u> </u>		PRESSURE GAUGE	_	
		TECHNICAL NOTE- APPLIES ONLY TO		
21		SHEET IN WHICH IT APPEARS. FOOD SERVICE EQUIPMENT TAG- REFER TO FOOD SERVICE		
(TP)		EQUIPMENT DRAWINGS FOR PLUMBING REQUIREMENTS TRAP PRIMER	-	
			_	
(DU)		TRAP PRIMER DISTRIBUTOR WATER METER	_	
M			-	
	DDV.	DDECOURE DELIES	-	
	PRV	PRESSURE RELIEF VALVE	_	
		FLANGED CONNECTION		
D		ECCENTRIC REDUCER		
		DIRECTIONAL FLOW ARROWS		
		STRAINER	-	
D.O.		UNION	-	
		DRAIN OFF BACKFLOW PREVENTION ASSEMBLY W/ SHUT-OFF	-	
A A A A A A A A A A A A A A A A A A A		VALVES & STRAINER	_	
		INDIRECT WASTE FUNNEL & DRAIN PIPE	_	
		CIRCULATION PUMP PIPE FREEZE ORIGIN OR END POINT - AS INDICATED	_	
*		NUMBER INDICATES PIPE FREEZE PROTECTION ZONE	-	
<u> </u>		TEMPERATURE & PRESSURE RELIEF VALVE		



DRAWN BY:

CHECKED BY:

PLUMBING ABBREVIATIONS

DESCRIPTION

INV.EL. PIPE INVERT ELEVATION

IW INDIRECT WASTE

KW KILOWATT

LAV LAVATORY

MR MOP RECEPTOR

MV MIXING VALVE

N/A NOT APPLICABLE

PPM PARTS PER MILLION

PRV PRESSURE REDUCING VALVE

PSI POUNDS PER SQUARE INCH

T&P TEMPERATURE & PRESSURE RELIEF VALVE

PTX PLUMBING THERMAL EXPANSION TANK

NG NATURAL GAS

SH SHOWER

SP SUMP PUMP

TP TRAP PRIMER

TYP. TYPICAL

UR URINAL

WB WALL BOX

WC WATER CLOSET

WH WALL HYDRANT

SK SINK

LBS POUNDS

B — -(A)— -

PROJECT NORTH

A R C H I T E C T S • E N G I N E E R S

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GSA FITOUT
40 MANSON LIBBY ROAD
SCARBOROUGH, ME 04074

FIRST FLOOR PLUMBING
REMOVALS PLAN

SHEET TITLE:

DRAWN BY:

CHECKED BY:

19

PD10

SCALE: DRAWN BY: CHECKED BY:

TECHNICAL NOTES:

1) SPACE RESERVED FOR ELECTRICAL - NO PIPING PERMITTED.

0 75% CONSTRUCTION DOCUMENTS 17 DEC 2019

REV. DESCRIPTION DATE



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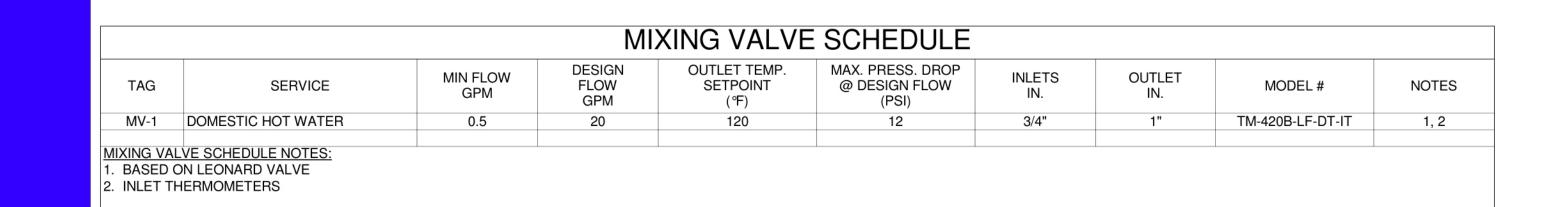
40 MANSON LIBBY ROAD
SCARBOROUGH, ME 04074

FIRST FLOOR PLUMBING PLAN

SHEET TITLE: WBRC CAD FILE: PROJECT No.

4290.10 GRAPHIC SCALE:

PROJECT MANAGER:



	PLUMBING	G FIXTI	JRE S	CHEDU	JLE		
TAG	DESCRIPTION	HW	CW	TRAP	WASTE	VENT	NOTES
WC-1	ADA - WALL HUNG WATER CLOSET	-	1"	-	3"	2"	
WC-2	ANTI-LIGATURE FLOOR MOUNTED WATER CLOSET / LAVATORY	-	1/2"	-	3"	2"	
UR-1	ADA - WALL MOUNTED URINAL	-	3/4"	-	2"	1-1/2"	
LAV-1	ADA - WALL MOUNTED LAVATORY	1/2"	1/2"	1-1/4"	1-1/2"	1-1/4"	SEE DETAIL
LAV-2	ADA - SOLID SURFACE LAVATORY DECK	1/2"	1/2"	1-1/4"	1-1/2"	1-1/4"	
SH-1	ADA - ONE-PIECE SHOWER	1/2"	1/2"	2"	2"	1-1/2"	SEE ARCH ELEV. FOR HEAD HEIGHT
SK-1	ADA - DROP-IN STAINLESS STEEL SINK	1/2"	1/2"	1-1/2"	1-1/2"	1-1/2"	
SK-2	ADA - DROP-IN STAINLESS STEEL SINK	1/2"	1/2"	1-1/2"	1-1/2"	1-1/2"	
EWC-1	ADA - DUAL-HEIGHT WALL HUNG WATER COOLER	-	1/2"	1-1/2"	1-1/2"	1-1/4"	
US-1	UTILITY SINK	1/2"	1/2"	3"	3"	2"	
TD-1	TRENCH DRAIN	-	-	4"	4"	2"	
FD-1	FLOOR DRAIN	-	-	2"	2"	1-1/2"	1/2" TRAP PRIMER
FD-2	SECURE FLOOR DRAIN	-	-	2"	2"	1-1/2"	1/2" TRAP PRIMER
WB-1	REFRIGERATOR CONNECTION BOX	-	1/2"	-	-	-	
WH-1	INTERIOR WALL HYDRANT	-	1/2"	-	-	-	
WH-2	EXTERIOR WALL HYDRANT	-	3/4"	-	-	-	

		PLUMBII	NG PUMP	SCHE	DULE				
TAG	SERVES	MODEL	TYPE	GPM	HEAD		ELECTRICAL	•	NOTES
					F1	HP	VOLT	PHASE	
HWP-1	DWH-1 HOT WATER RECIRC	007-SF5	SS CARTRIDGE	3	8	1/25	115	1	1, 2
	AD COLUED III E MOTEO								
PLUMBING PU	MP SCHEDULE NOTES:								

PLUMBING PUMP SCHEDULE NOTES:


1. BASED ON TACO

2. STAINLESS STEEL CONSTRUCTION

		DOMES	TIC WAT	ER HEATE	R SCHE	ULE		
TAG	MODEL	FIRST HOUR RATING GPH	COIL MBH	BOILER HOT WATER FLOW GPM	BOILER HOT WATER WPD FT-HD	STORAGE GAL	OPERATING WEIGHT LBS	NOTES
DWH-1	SSU-80	330	212	12	9.1	80	1,200	1, 2, 3
1. BASED ON 2. FIRST HOU	ER SCHEDULE NOTES: HTP IR RATING BASED ON 90°F T NOCE BASED ON 180°F BOIL							

		7	HERMA	AL EXPA	NSION	TANK S	CHEDI	JLE		
TAG	SERVES	MODEL		TANK		MOUNTING	HW	ASME	ACCEPTANCE	NOTES
IAG	SERVES	WODEL	VOLUME	DIAMETER	HEIGHT	WOONTING	TEMP	PSIG	VOLUME	NOTES
	***************************************	200	(GAL.)	(IN.)	(IN.)		(°F)		(GAL.)	
PXT-1	DWH-1	ST-12C	6.4	12	14	PIPE	140	150		1
HERMAL EX	KPANSION TANK	SCHEDULE NO	TES:							
. BASED ON										

	7	RAP PRII	MER SCH	IEDULE		
TAG	MODEL	INLET SIZE	OUT	LETS	MOUNTING	NOTES
			QTY	CONNECTION		
TP-1	P1-500	1/2"	1-4	1/2"	UPWARD TEE	1, 2, 3
<u> TRAP PRIMER</u>	R SCHEDULE NOTES:					
1. BASED ON	PRECISION PLUMBING PRO	DUCTS				
2. MOUNTED	ABOVE CEILING					
3. DISTRIBUT	ION UNIT REQUIRED TO SEF	RVE MULTIPLE FLO	OR DRAINS			

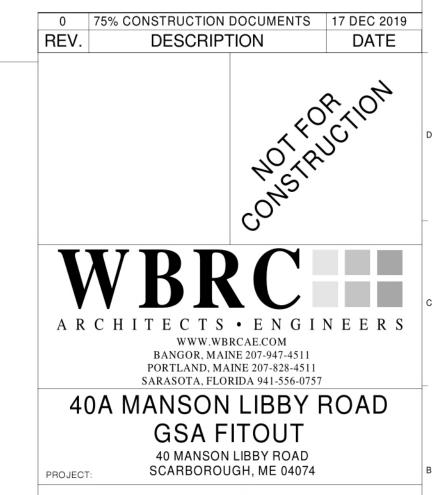

PLUMBING SCHEDULES

SHEET TITLE:

WBRC CAD FILE:

PROJECT No. 4290

DRAWN BY:


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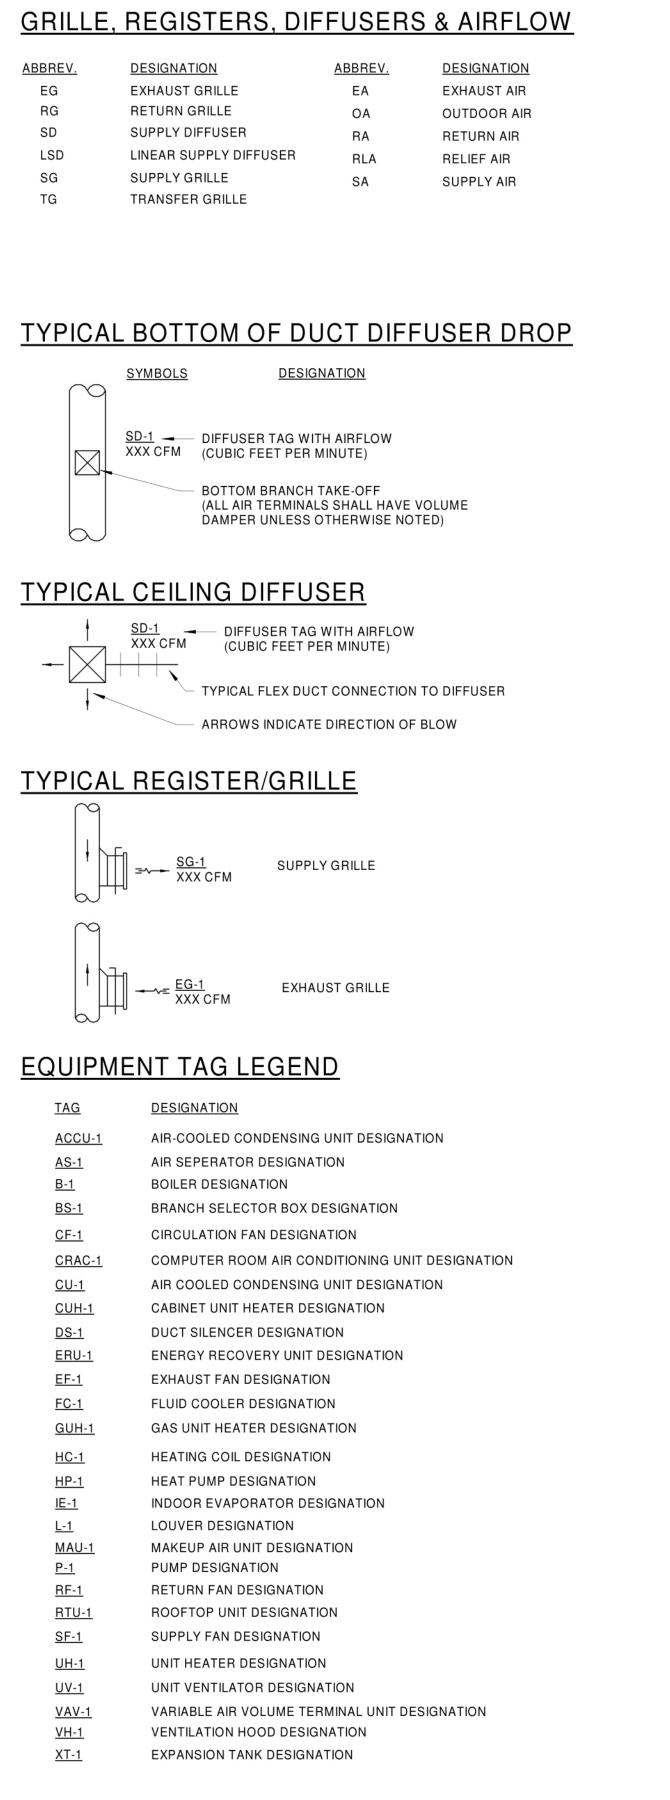
PROJECT No. 4290.10 GRAPHIC SCALE:

SCALE: AS NOTED

PROJECT MANAGER: (b)(6); (b)(7)(C) SHEET No.

PL601



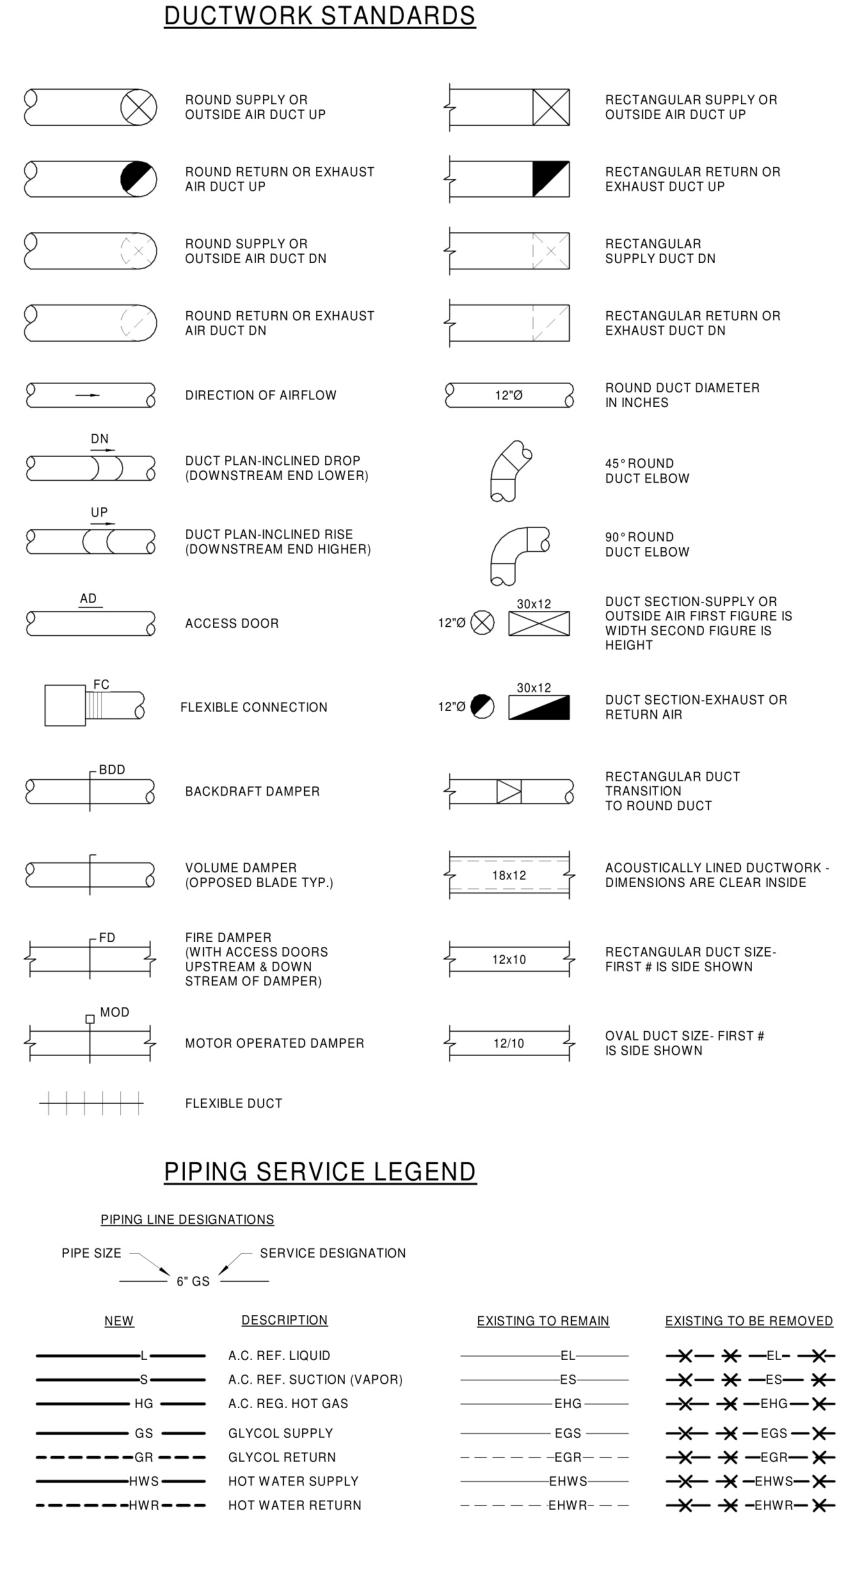


<u>NEW</u>	DESCRIPTION	EXISTING TO REMAIN	EXISTING TO BE REMO
→	– BALANCING VALVE	E	— ×—>≴1 ^R ×—
Ĵ	- CONTROL VALVE	E	- XR - X
~		E	-x-1\$1 ^R x-
-	- TRIPLE DUTY VALVE	E E	~ ₩ ^
•	- SHUT-OFF VALVE	E	R
	- BACKFLOW PREVENTER	E	— X— — X —
1	_ CHECK VALVE		-×/1×-
0	- FLOW CONTROL VALVE	E	— ×— ©—×—
+>+	STRAINER W/DRAIN & HOSE CONN.	E	- X
<u> </u>	- CONTROL VALVE (3-WAY)	E	- XXXXXXXX
 —	– PRESSURE RELIEF VALVE		- * - \$\bar{\bar{\bar{\bar{\bar{\bar{\bar{
Ţ	_		- × + × -
	PRESSURE REDUCING VALVE (WATER)	E	— ×— \
	DIFFERENTIAL PRESSURE REGULATING VALVE		P
s s	- FUEL OIL FUSIBLE SHUT-OFF	E	— ×— \$\frac{1}{2} \text{R} \times
\mathbb{R}	- FLOW SWITCH	E	— X——X ————————————————————————————————
	- FLOW SWITCH	E	R
<u> </u>	CONTROL GROUP		
<u> </u>	THERMOSTAT	E	₹ ₈
<u>\$</u>	TEMPERATURE SENSOR	E D.O.	* D.O.
©CO2	CO2 WALL SENSOR	— ————————————————————————————————————	***
(E)	HVAC SYSTEM EMERGENCY SHUT OFF SWITCH		
D.O.	DRAIN-OFF VALVE		
	- UNION		
	- INCREASER OR DECREASER CONCENTRIC		
7	- INCREASER OR DECREASER ECCENTRIC		
	- INCREASER OR DECREASER ECCENTRIC DRIP LEG		
—			
→ → →	DRIP LEG - AUTOMATIC AIR VENT		
<u>†</u>	DRIP LEG - AUTOMATIC AIR VENT - PIPE GUIDE		
→ → - - - -	DRIP LEG - AUTOMATIC AIR VENT		
<u>†</u>	DRIP LEG - AUTOMATIC AIR VENT - PIPE GUIDE - PIPE ANCHOR		
	DRIP LEG AUTOMATIC AIR VENT PIPE GUIDE PIPE ANCHOR DIRECTION OF FLOW		
→ — — — — — — — — — — —	DRIP LEG AUTOMATIC AIR VENT PIPE GUIDE PIPE ANCHOR DIRECTION OF FLOW PIPE CAP		
	DRIP LEG AUTOMATIC AIR VENT PIPE GUIDE PIPE ANCHOR DIRECTION OF FLOW PIPE CAP ELBOW UP OR RISE		
→ — × — — — — — — — — — —	DRIP LEG AUTOMATIC AIR VENT PIPE GUIDE PIPE ANCHOR DIRECTION OF FLOW PIPE CAP ELBOW UP OR RISE ELBOW DOWN OR DROP		
→ — — — — — — — — — — — — — — — — — — —	DRIP LEG AUTOMATIC AIR VENT PIPE GUIDE PIPE ANCHOR DIRECTION OF FLOW PIPE CAP ELBOW UP OR RISE ELBOW DOWN OR DROP THERMOMETER		
→ — — — — — — — — — — — — — — — — — — —	DRIP LEG AUTOMATIC AIR VENT PIPE GUIDE PIPE ANCHOR DIRECTION OF FLOW PIPE CAP ELBOW UP OR RISE ELBOW DOWN OR DROP THERMOMETER PRESSURE GAUGE		
→	DRIP LEG AUTOMATIC AIR VENT PIPE GUIDE PIPE ANCHOR DIRECTION OF FLOW PIPE CAP ELBOW UP OR RISE ELBOW DOWN OR DROP THERMOMETER PRESSURE GAUGE LOW WATER CUT-OFF TECHNICAL NOTE- APPLIES ONLY TO		

MISCELLANEOUS ABBREVIATIONS GENERAL NOTES

ABBREV.	DESIGNATION	1.	ALL NEW SPACE THERMOSTATS SHALL BE MOUNTED 4'-0" ABOVE FINISHED FLOOR (AFF).
Α	ANCHOR		, ,
AD	ACCESS DOOR	2.	EQUIPMENT, DUCTWORK AND PIPING LOCATIONS SHOWN ARE APPROXIMATE
AFF	ABOVE FINISHED FLOOR		EXCEPT WHERE DIMENSIONED. EXACT LOCATIONS SHALL BE DETERMINED BY THE
APD	AIR PRESSURE DROP		CONTRACTOR TO AVOID INTERFERENCES.
AWT	AVERAGE WATER TEMPERATURE	3.	FLEXIBLE CONNECTIONS SHALL BE
BD	BAROMETRIC DAMPER	0.	PROVIDED BETWEEN MOTORIZED UNITS AND
BDD	BACKDRAFT DAMPER		DUCTWORK CONNECTIONS.
BOS	BOTTOM OF STEEL	4.	PROVIDE ACCESS DOORS IN EQUIPMENT
BTU	BRITISH THERMAL UNITS		AND DUCTWORK FOR ACCESS TO DAMPERS, MOTORS, FILTERS, FANS AND ON BOTH
BV	BRICK VENT		SIDES OF HEATING COILS.
CD	COOLING CONDENSATE DRAINAGE	5.	PIPING SHALL BE RUN AS DIRECT AS
CFM	CUBIC FEET PER MINUTE		POSSIBLE, PARALLEL TO & FORMING RIGHT ANGLES TO THE LINES OF THE BUILDING,
D	DRAIN		SUPPORTED FROM THE STRUCTURE, FREE
DB	DRY BULB		FROM POCKETS & SAGS & PITCHED TO LOW POINT DRAINS.
EAT	ENTERING AIR TEMP.	6	LOCATE ALL VALVES FOR EASY ACCESS &
ECC	ECCENTRIC	0.	OPERATION. DO NOT LOCATE VALVES
EL	ELEVATION		W/STEMS BELOW HORIZONTAL.
EWT	ENTERING WATER TEMPERATURE	7.	ALL EXTERIOR WALL PENETRATIONS SHALL
FA	FRESH AIR		BE SEALED WEATHERTIGHT.
FC	FLEXIBLE CONNECTION	8.	ALL EQUIPMENT SHALL BE INSTALLED
FD	FIRE DAMPER		ACCORDING TO MANUFACTURERS RECOMMENDATIONS.
FLA	FULL LOAD AMPS	9.	DUCTWORK SHALL BE COORDINATED TO PREVENT ANY INTERFERENCES W/
GPM	GALLONS PER MINUTE		PLUMBING, PIPING, ELECTRICAL,
HP	HORSEPOWER		STRUCTURAL, FIRE PROTECTION, ARCHITECTURAL AND OTHER WORK.
HVAC	HEATING, VENTILATING	4.0	
HZ	& AIR CONDITIONING HERTZ	10.	ALL DUCT SIZES SHOWN ARE CLEAR INTERNAL DIMENSIONS.
LAT	LEAVING AIR TEMP.	11	CONTRACTOR TO FIELD VERIFY ALL
LF	LINEAL FEET	11.	EXISTING DUCT SIZES, PIPE SIZES,
LRA	LOCKED ROTOR AMPS		LOUVERS, ETC. INCLUDING LOCATIONS & ARRANGEMENTS OF SAME. COORDINATE
LWCO	LOW WATER CUT-OFF		NEW WORK WITH EXISTING CONDITIONS.
LWT	LEAVING WATER TEMPERATURE		
MAX	MAXIMUM		
МВН	THOUSAND BRITISH THERMAL		
	UNITS PER HOUR		
MD	MANUAL DAMPER		
MIN	MINIMUM		
MOD	MOTOR OPERATED DAMPER		
MV	MANUAL VENT		
N.C.	NORMALLY CLOSED		
PD	PRESSURE DROP		
RIC	RUN IN COVER		
RPM	REVOLUTIONS PER MINUTE		
SP	STATIC PRESSURE		
TOS	TOP OF STEEL		
TV	TURNING VANES		
TYP.	TYPICAL		
٧	VENT		
VD	VOLUME DAMPER		
W/	WITH		
WB	WET BULB		
E	EXISTING TO REMAIN		
ER	EXISTING RELOCATED		
RR	REMOVE & RELCOATE EXISTING		
R	EXISTING TO BE REMOVED		
NR	NEW TO REPLACE EXISTING IN EXISTING	G LOCATIO	N

SECTION & DETAIL MARKERS

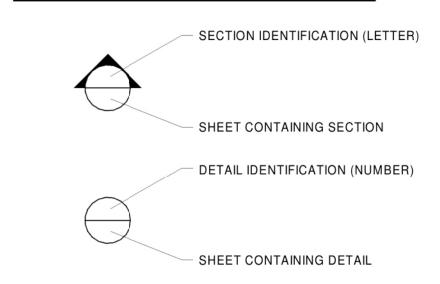

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REV. DESCRIPTION DATE

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GSA FITOUT

40 MANSON LIBBY ROAD
SCARBOROUGH, ME 04074

MECHANICAL LEGEND

SHEET TITLE:

WBRC CAD FILE:

PROJECT No. AS NOTED

SCALE: 1/4" = 1'-0"

PROJECT MANAGER: (b)(6); (b)(7)(C)

DRAWN BY: M-001

CHECKED BY:

DUCT SMOKE DETECTOR

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REV. DESCRIPTION DATE WWW.WBRCAE.COM BANGOR, MAINE 207-947-4511 PORTLAND, MAINE 207-828-4511 SARASOTA, FLORIDA 941-556-0757 40A MANSON LIBBY ROAD GSA FITOUT 40 MANSON LIBBY ROAD SCARBOROUGH, ME 04074 FIRST FLOOR MECHANICAL REMOVALS PLAN

SHEET TITLE: WBRC CAD FILE: 4290.10 GRAPHIC SCALE: PROJECT No.

1/4" = 1'-0" SCALE: PROJECT MANAGER: DRAWN BY:

CHECKED BY:

GENERAL NOTES:

1. ALL HOT WATER SUPPLY & RETURN BRANCHES
TO TERMINAL EQUIPMENT SHALL BE 3/4" UNLESS
NOTED OTHERWISE.

TECHNICAL NOTES:

SPACE RESERVED FOR ELECTRICAL - NO PIPING OR DUCTWORK PERMITTED.

O 75% CONSTRUCTION DOCUMENTS 17 DEC 2019
REV. DESCRIPTION DATE

PROJECT NORTH

CONSTRUCTION DOCUMENTS 17 DEC 2019
DATE

PROJECT NORTH

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40 MANSON LIBBY ROAD

SCARBOROUGH, ME 04074

FIRST FLOOR MECHANICAL PLAN

SHEET TITLE:

WBRC CAD FILE:

PROJECT No. 4290.10 GRAPHIC SCALE:

0"


SCALE: 1/4" = 1'-0"

PROJECT MANAGER: (b)(6);
(b)(7)(C) SHEET No.

M - 101

CHECKED BY:

M-101

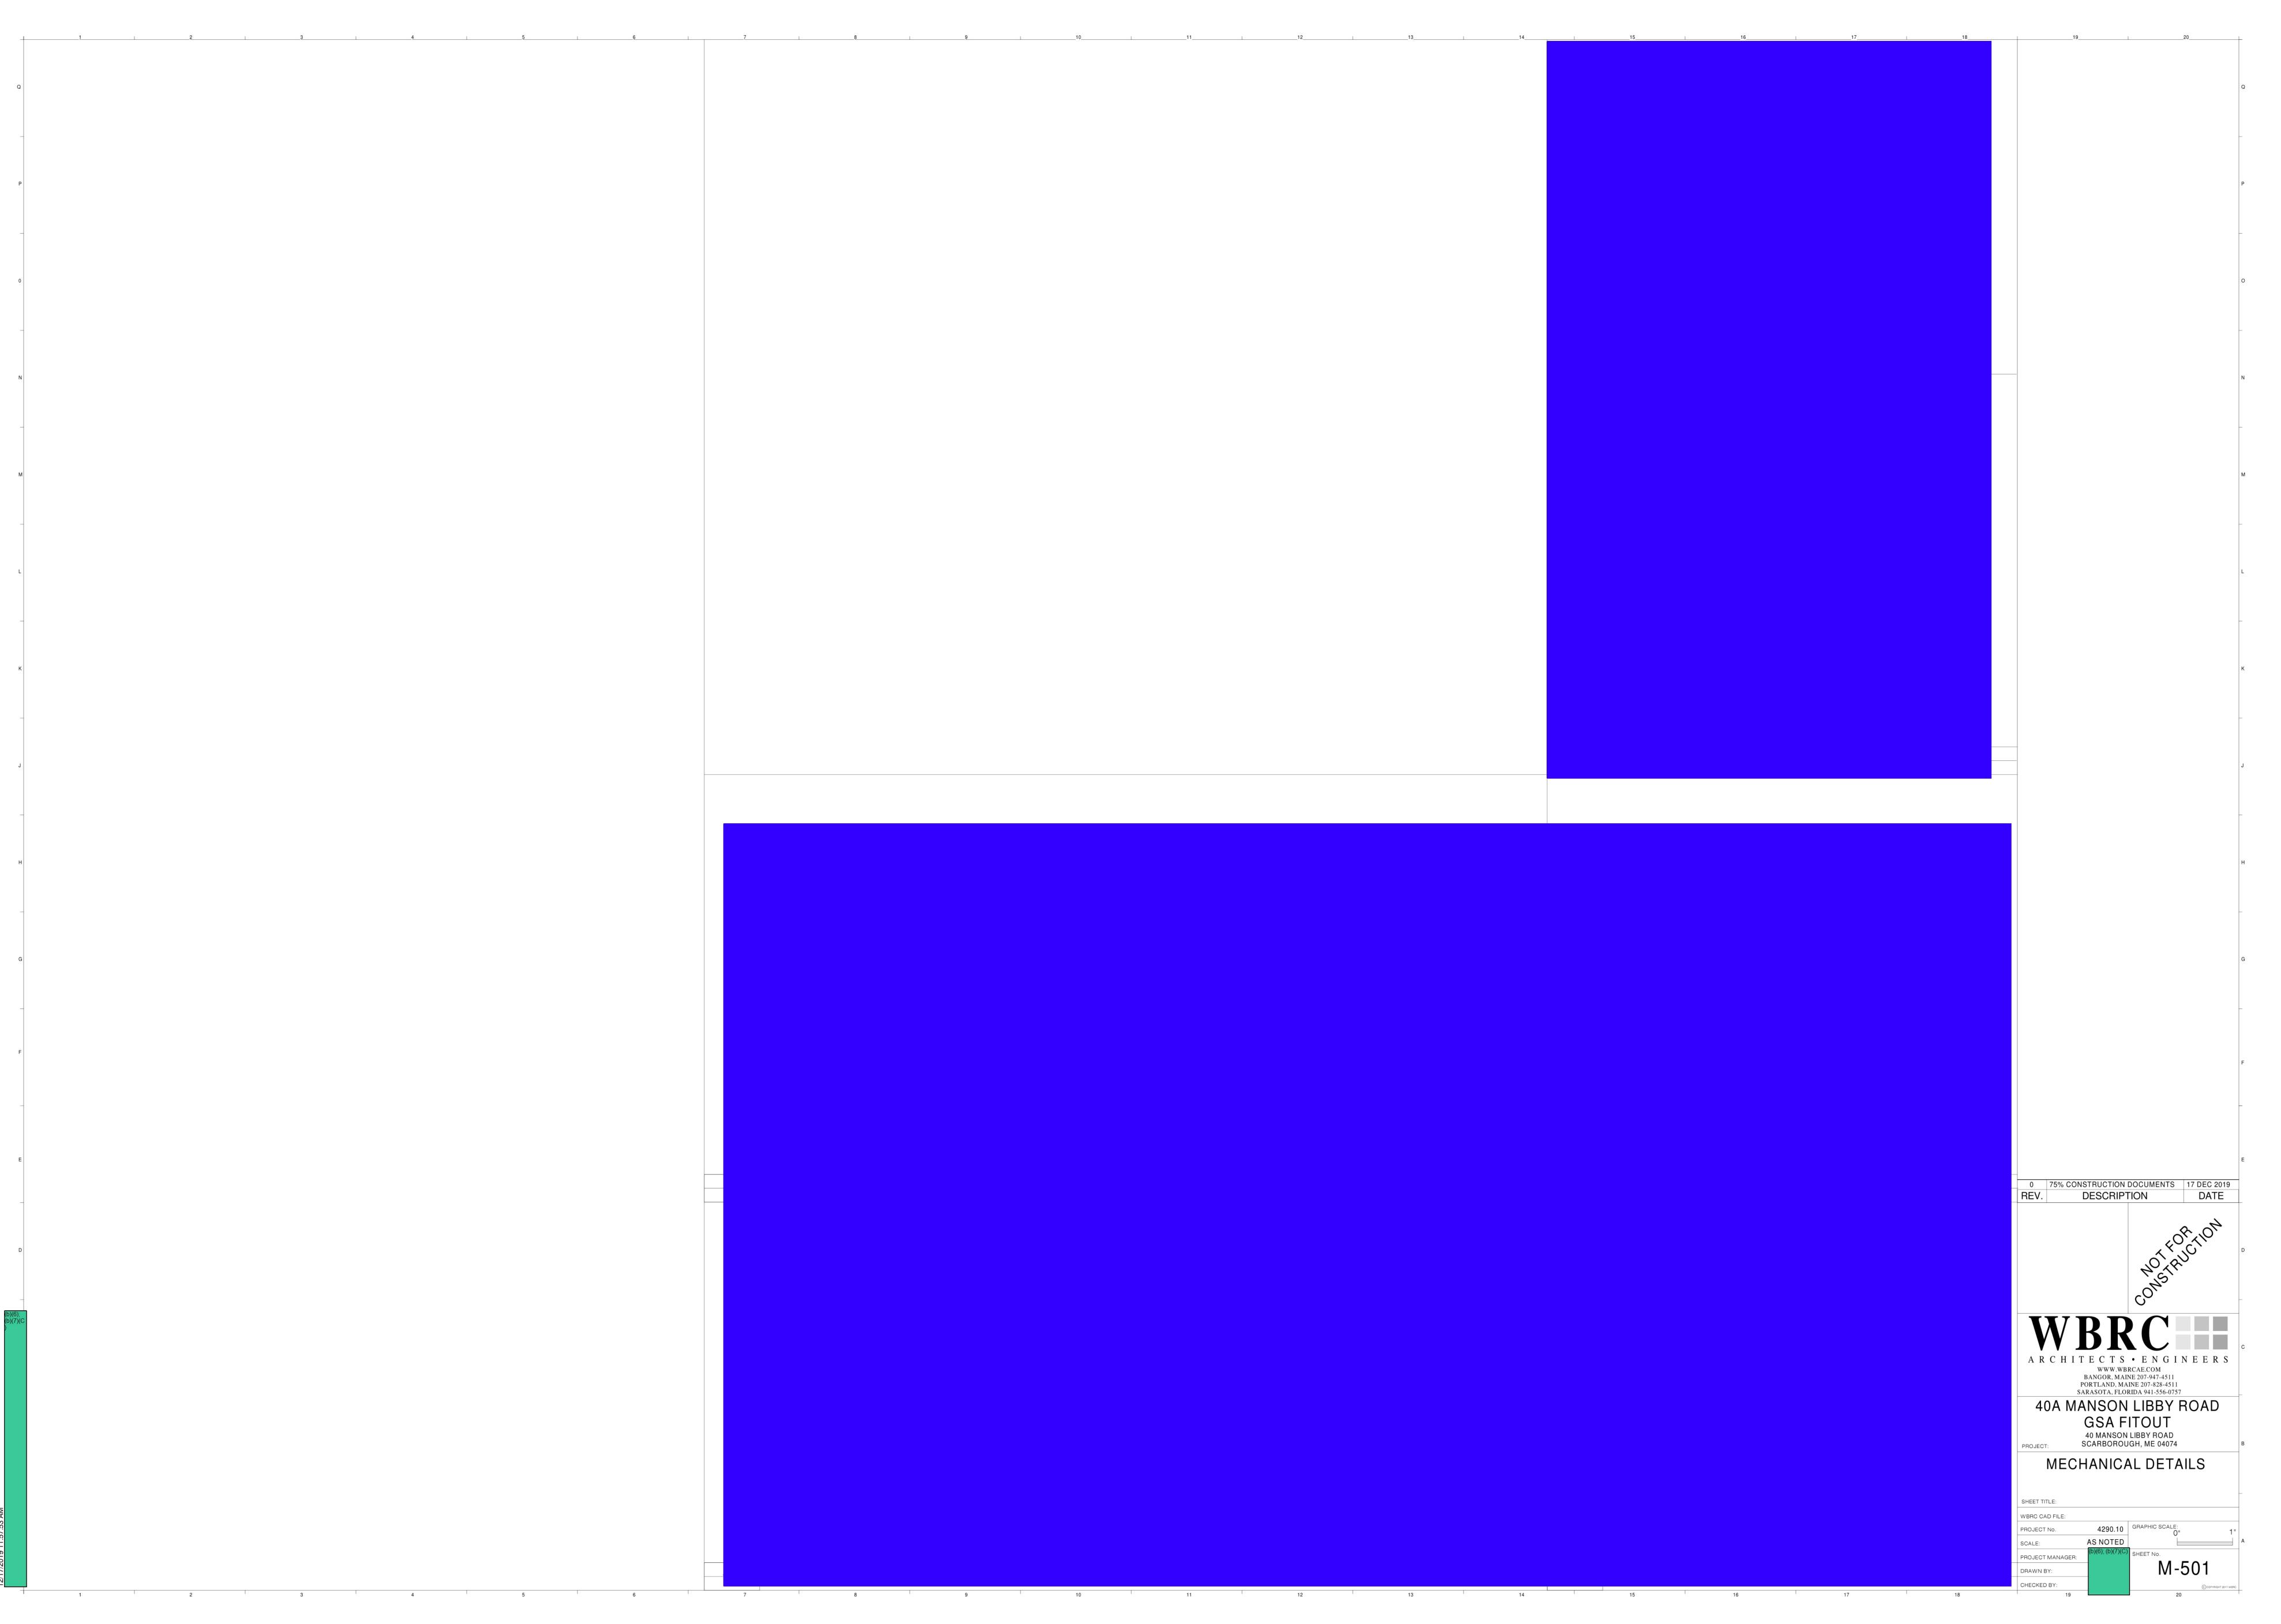

			PUMP S	CHEDU	JLE				
TAG	SERVES	MODEL	TYPE	GPM	HEAD FT		ELECTRICAL	-	NOTES
					F1	HP	VOLT	PHASE	
P-1	BOILER INJECTION PUMP	IL0011	INLINE	17.9	10	1/8	120	1	1, 2
P-2	HW SYSTEM PUMP	VR20-3	INLINE	18.7	40	1.1	208	1	1, 3
P-3	DOM. WATER HEATER	IL0011	INLINE	12	15	1/8	120	1	1
PUMP SCHE	DULE NOTES:								
1. BASED ON	N TACO								
2. BASED ON	N 30°F ΔT THRU BOILER								
3. VARIABLE	SPEED PUMP WITH INTEGRA	L VFD							

		EXPA	NOISNA	TANK S	CHEDUL	_E	
TAC	SERVICE	MODEL #		TANK		ACCEPTANCE	NOTEC
TAG	SERVICE	MODEL#	VOLUME	DIA.	HEIGHT	VOLUME	NOTES
XT-1	HOT WATER SYSTEM	CBX-					1
XPANSION	I TANK SCHEDULE NOTES:						
. BASED (ON TACO						

		RADIA	NT CEII	LING F	PANEL	SCHE	DULE			
						SIZE	(IN)	AVC WATER	ГАТ	
TAG	TYPE	STYLE	BTU/HR	GPM	WPD	LENGTH (IN)	WIDTH (IN)	AVG WATER TEMP °F	EAT °F	NOTES
RP-1	MODULAR LAY-IN PANEL	6-PASS	1,080	0.50	0.12	48	24	145	70	1, 2, 3
BASED OF	ILING PANEL SCHEDULE NOTES: N STERLING									
PROVIDE	COLOR AS SELECTED BY ARCHITE	:CT								
	WITH FACTORY CUT FOIL FACED I									

TAG	SERVICE	MODEL#	GPM	SIZE	DIA	HEIGHT	MAX GPM	NOTES
AS-1	HOT WATER SYSTEM	4902AT	19	2"	10"	16-1/2"	51	1

3. CONDENSATE NEUTRALIZATION KIT

4. PROVIDE POLYPROPYLENE COMBUSTION / VENT AIR PIPING AND CONCENTRIC VENT

6. HOT WATER LOOP PUMP ENABLED BY FACTORY BOILER CONTROLLER, WIRING BY DIVISION 26.

5. BOILER INJECTION PUMP POWERED BY FACTORY BOILER CONTROLLER.

TAG	MODEL	LP GAS INPUT	AFUE EFFICIENCY	NAT GAS PRESSURE	VENT AIR CONNECTION	COMB AIR CONNECTION		ELECTRICAL	-	NOTES
		MBH	%	IN-WC	IN	IN	MCA	VOLT	PHASE	
B-1	EFT-285	285	95	3.5 - 14	3"	3"	6.3	120	1	1, 2, 3, 4, 5,

TAG	SERVES	MODEL	SIZE	MIN	HEAT	MAX	APD				HOT WA	TER COIL				NOTE
TAG	SERVES	MODEL	SIZE	CFM	CFM	CFM	APD	EAT °F	LAT °F	MBH	GPM	WPD	ROWS	EWT °F	LWT °F	NOTE
/AV-11	STORAGE & SALLY PORT	VCWF	8"Ø	380	380	380	0.13	55	104	20.0	2.50	0.9	2	160	143	1, 2,
/AV-12	HOLDING ROOMS	VCWF	6"Ø	120	180	180	0.07	55	107	10.2	1.00	0.2	2	160	139	1, 2, 3
VAV-13	MAT FITNESS	VCWF	6"Ø	150	200	300	0.15	55	105	10.9	1.00	0.2	2	160	138	1, 2, 3
VAV-14	PROCESSING & INTERVIEW	VCWF	6"Ø	200	250	360	0.21	55	105	13.6	1.50	0.3	2	160	141	1, 2, 3
VAV-15	LOCKER ROOMS & ALIEN FILE	VCWF	8"Ø	390	390	390	0.14	55	93	16.1	1.00	0.2	2	160	127	1, 2, 3
VAV-16	CONFERENCE ROOM	VCWF	6"Ø	150	200	390	0.25	55	105	10.9	1.00	0.2	2	160	138	1, 2, 3
VAV-21	OPEN OFFICE	VCWF	10"Ø	400	650	860	0.26	55	99	30.8	2.50	1.2	2	160	135	1, 2,
VAV-22	LOBBY, RESTROOM & VESTIBULE	VCWF	6"Ø	150	200	310	0.16	55	105	10.9	1.00	0.2	2	160	138	1, 2, 3
VAV-23	OCIO STAGING, SUPPORT, BREAK & CORRIDOR	VCWF	8"Ø	200	200	565	0.24	55	108	11.6	1.00	0.2	2	160	136	1, 2,
VAV-24	EXTERIOR OFFICES	VCWF	6"Ø	100	200	265	0.12	55	110	11.9	1.50	0.3	2	160	144	1, 2,
ABLE AIR \	/OLUME BOX SCHEDULE															

						SUPPLY FAN						
TAG	SEF	RVES	CFM	MIN OUTSIDE AIR CFM	ESP	TSP	ВНР	HP	POWER	TYPE	SIZE IN.	RPM
RTU-1	BUILDIN	G NORTH	2,000	300	0.75	-	0.86	1.0	208/3/60	DIRECT		1,060
RTU-2	BUILDIN	IG SOUTH	2,000	300	0.75	-	0.86	1.0	208/3/60	DIRECT		1,060
					DIRECT E	EXPANSION COO	LING COIL					
TAG	AREA	ROWS	FPI	EAT °F	LAT °F	REFG.	EER	# CIRCUITS	# OF COMP	TOTAL MBH	SENS MBH	AMBIENT TEM
RTU-1				80 / 67	59 / 57	R-410A	13	1	1	57.4	42.7	95
RTU-2				80 / 67	59 / 57	R-410A	13	1	1	57.4	42.7	95
					GA	S HEATING SECT	TION					
TAG	INPUT	OUTPUT	EAT °F	LAT °F	FUEL	AFUE %	GAS CONN.	REC'D GAS	PRESSURE	HEAT EXCH MAT.	BURNER TYPE	CAPACITY CONTROL
RTU-1	60	49	48	71	NAT GAS	80	1/2"	4.5 - 13	.5 IN-WC	SS	INDIRECT	SNGL STG
RTU-2	60	49	48	71	NAT GAS	80	1/2"	4.5 - 13	.5 IN-WC	SS	INDIRECT	SNGL STG
			ELEC	TRICAL			•					
UNIT	POWER	SUPPLY FAN FLA	EXH. FAN FLA	COND FAN FLA	COMP. RLA	UNIT MCA	UNIT MOCP	FILTERS	MODEL	WEIGHT	NO	TES
RTU-1	208/3/60	9.4	N/A	2.5	16.2	33.0	45	2" / MERV 8	YHC067E3RXA	1,000	1, 2, 3, 4	, 5, 6, 7, 8
RTU-2	208/3/60	9.4	N/A	2.5	16.2	33.0	45	2" / MERV 8	YHC067E3RXA	1,000		, 5, 6, 7, 8

 BASED ON TRANE
 ADAPTER CURB - FIELD VERIFY EXISTING BASE CURB DIMENSIONS. 3. DOUBLE WALL CABINET WITH 1" FOAM INSULATION. 4. 0-100% ECONOMIZER WITH OUTSIDE AIR HOOD & RELIEF AIR HOOD. 5. FACTORY MOUNTED SMOKE DETECTOR IN SUPPLY FAN SECTION

6. FIELD POWERED SERVICE RECEPTACLE. 7. 2" PLEATED MERV 13 FILTERS

3. CLOSED CELL FOAM LINER

8. MULTIZONE VAV OPERATION AND CO2 CONTROL

			DIFFUSEF	R / GRILLE	E AND REC	SISTER	SCHEDULE			
TAG	DESCRIPTION	NECK SIZE (W x H)	MAX CFM	SP (IN-WC)	THROW FT	NC	TYPE	MODEL	MOUNTING	NOTES
SD-1	SUPPLY AIR DIFFUSER	6 x 6	140	0.068	6-9-13	<15	4-WAY	24x24/SMCD/TYPE 3P	LAY-IN	1, 2
SD-2	SUPPLY AIR DIFFUSER	10 x 10	250	0.028	7-9-14	<15	4-WAY	24x24/SMCD/TYPE 3P	LAY-IN	1, 2
SD-3	SECURE SUPPLY AIR DIFFUSER	6"Ø	80	0.075	3-4-8	<15	PERFORATED	24x24/PDMC	LAY-IN	1, 2, 3, 5
SD-4	SUPPLY AIR DIFFUSER	8 x 8	225	0.057	8-10-16	<15	2-WAY	SMCD/TYPE 1	SURFACE	1, 2, 5
SG-1	WALL SUPPLY AIR GRILLE	14 x 6	230	0.045	10-14-22	<15	DBL. DEFLECTION	520-L	SURFACE	1, 2, 4
RG-1	RETURN AIR GRILLE	10 x 10	300	0.029	-	<15	45° DEFLECTION	535-TBP	LAY-IN	1, 2
RG-2	RETURN AIR GRILLE	22 x 22	900	0.029	-	<15	45° DEFLECTION	535-TB	LAY-IN	1, 2
EG-1	EXHAUST AIR GRILLE	10 x 10	200	0.035	-	<15	45° DEFLECTION	635	SURFACE	1, 2, 5
EG-2	EXHAUST AIR GRILLE	14 x 6	230	0.029	-	<15	0° DEFLECTION	510-Z-L	SURFACE	1, 2
EG-3	SECURE EXHAUST AIR GRILLE	8 x 8	100	0.033	-	<15	45° DEFLECTION	24x24/98-TBP	LAY-IN	1, 2, 3, 5

	FAN SCHEDULE																	
TAG	SERVES	TYPE	MODEL	CFM	ESP IN-WC	FAN RPM	REQ'D BHP		ELECTRICAL	-	WEIGHT LBS.	NOTES						
					114-440	111 101	DI 11	HP	VOLT	PHASE	PHASE							
EF-1	BUILDING EXHAUST	ROOF MOUNTED DOWNBLAST	G-123-VG	940	0.5	1113	0.13	1/4	120	1	100	1, 2, 3						
EF-2	TOILET ROOM	CEILING EXHAUST FAN	SP-A90	75	0.15	773	N/A	10 W	120	1	15	1, 4, 5, 6						
AN SCHEDU	JLE NOTES:																	
. BASED ON	I GREENHECK																	
	I GREENHECK																	

2. 24" HIGH INSULATED ROOF CURB WITH DAMPER TRAY 3. 24V MOTOR OPERATED DAMPER 4. WHITE ALUMINUM GRILLE, ISOLATION KIT, AND SPEED CONTROLLER 5. GALVANIZED HOUSING AND WHEEL 6. WALL CAP EQUAL TO SEIHO-SFB-P

4. BASED ON STERLING

3. FIELD CONFIRM COMPATIBILITY WITH SECURITY CEILING TYPE AND HOLD-DOWN CLIPS.

5. OPPOSED BLADE DAMPER ADJUSTABLE THROUGH FACE OF GRILLE WHERE NOTED ON PLANS.

4. PERFORMANCE BASED ON 22-1/2 DEG FRONT BLADE ANGLE

TAG	SERVES	TYPE	MODEL	UNIT H	IEATEF	R SCHE	EDULE WPD	EWT	RPM		ELECTRICAI	-	NOTES
								°F		HP	VOLT	PHASE	
CUH-1	STAFF ENTRY	WALL RECESSED	W42	53	3.5	1.0	0.17	160	3200	1/30	120	1	1, 2, 3
CUH-2	VESTIBULE	WALL RECESSED	W84	103	7	1.0	0.22	160	3200	1/30	120	1	1, 2, 3
UH-1	SALLY PORT	HORIZONTAL	HS-36	550	18.6	2.7	0.09	160	1550	1/30	120	1	2, 4
NIT HEATI	ER SCHEDULE NOTES:												
BASED O	N BEACON MORRIS												
PROVIDE	COLOR AS SELECTED	BY ARCHITECT											
. PROVIDE	WALL RECESS KIT												

			IVII	NI SPLIT S	SYSTEMA	AC SCHED	ULE		
	COOLING	AIRFLOW	ELEC	TRICAL	REFG. P	IPE CONN.			
UNIT	CAPACITY (BTU/H)	CFM	VOLTS	AMPS LIQUID		SUCTION	WEIGHT	MODEL NO.	SERVES
IE-1	12,000	425	208/1	1	1/4	1/2	29	PKA-A12HA6	IT ROOM
UNIT	COOLING CAPACITY	SEER	REFG		ELECTRICAL		WEIGHT	MODEL NO.	NOTES
	(BTU/H)			VOLTS	MCA	MAX FUSE			
ACCU-1	12,000	15.2	R-410A	208/1	13.0	15	82	PUY-A12NHA6	1, 2, 3, 4, 5

1. BASED ON MITSUBISHI
2. PROVIDE WITH WIND BAFFLE FOR COOLING OPERATION DOWN TO -20°F
3. FACTORY SUPPLIED, FIELD INSTALLED CONDENSATE LIFT PUMP. CONCEALED BEHIND COVER. 4. PROVIDE WITH WIRED THERMOSTAT WITH LCD DISPLAY

DESCRIPTION WWW.WBRCAE.COM BANGOR, MAINE 207-947-4511 PORTLAND, MAINE 207-828-4511 SARASOTA, FLORIDA 941-556-0757 40A MANSON LIBBY ROAD **GSA FITOUT** 40 MANSON LIBBY ROAD SCARBOROUGH, ME 04074

MECHANICAL SCHEDULES

0 75% CONSTRUCTION DOCUMENTS 17 DEC 2019

SHEET TITLE: WBRC CAD FILE: 4290.10 GRAPHIC SCALE: PROJECT No. SCALE: PROJECT MANAGER:

DRAWN BY: CHECKED BY:

LEGEND:

ALL DEVICES, FIXTURES, ETC. SHALL BE NEW UNLESS DESIGNATED WITH THE FOLLOWING TAGS: ER EXISTING RELOCATED NR NEW TO REPLACE EXISTING IN EXISTING LOCATION EXISTING TO BE REMOVED

EMERGENCY LIGHT

RR REMOVE AND RELOCATE EXISTING

FLUORESCENT FIXTURE - UPPERCASE LETTER IS TYPE, LOWERCASE LETTER IS SWITCH CONTROL GROUP RECTANGLES INDICATE NUMBER FIXTURES IN A ROW.

CEILING MOUNTED FIXTURE - NOTES SAME AS ABOVE WALL MOUNTED FIXTURE - NOTES SAME AS ABOVE

WALL MOUNTED LINEAR FIXTURE - NOTES SAME AS ABOVE

| TRACK LIGHTING - NOTES SAME AS ABOVE CEILING MOUNTED EXIT SIGN - ARROW INDICATES DIRECTIVE ARROW ON SIGN

WALL MOUNTED EXIT SIGN - ARROW INDICATES DIRECTIVE ARROW ON SIGN EMERGENCY LIGHTING BATTERY PACK WITH EMERGENCY LAMPS AS SHOWN

REMOTE EMERGENCY LAMP LIGHT FIXTURES

SPST FLUSH WALL TOGGLE SWITCH - MOUNT AT 48" A.F.F TO CENTER - LETTER INDICATES SWITCH GROUP

THREE-WAY TOGGLE SWITCH - NOTES SAME AS SPST SWITCH ABOVE DIMMER SWITCH - NOTES SAME AS SPST SWITCH ABOVE

LOW VOLTAGE DIMMER SWITCH - NOTES SAME AS SPST SWITCH ABOVE

FOUR-WAY TOGGLE SWITCH - NOTES SAME AS SPST SWITCH ABOVE WALL KEY SWITCH - NOTES SAME AS ABOVE

PILOT LIGHT SWITCH - NOTES SAME AS ABOVE

VACANCY SENSOR - MANUAL ON / AUTOMATIC OFF OPERATION - NOTES SAME AS ABOVE- "a/b" DENOTES DUAL RELAY SENSOR (SINGLE SWITCH W/ (2) RELAYS IS REQUIRED)

VOLUME CONTROL SWITCH - NOTES SAME AS ABOVE LOW VOLTAGE SWITCH - NOTES SAME AS ABOVE

PROJECTION SCREEN CONTOL SWITCH

FADER STATION SWITCH

CEILING MOUNTED OCCUPANCY SENSOR - "LN" INDICATES LINE VOLTAGE

CORNER MOUNTED OCCUPANCY SENSOR

POWER PACK FOR LOW VOLTAGE LIGHTING CONTROL DEVICES

EC EMERGENCY LIGHTING CONTROL UNIT

PHOTO CELL

20 AMP DUPLEX CONVENIENCE RECEPTACLE - MOUNT AT 18" A.F.F. TO CENTER UNLESS NOTWD OTHERWISE "GFI" INDICATES GROUND FAULT DEVICE, "U" INDICATES MOUNTED AT 48" OR 6" ABOVE BACKSPASH OR COUNTER,
WHICHEVER IS LOWER - "*" INDICATES GFI PROTECTED BY UPSTREAM DEVICE, "WP" INDICATES WEATHERPROOF,
"IG" INDICATES INSULATED/ISOLATED GROUND, "C" INDICATES CEILING MOUNTED, "F" INDICATES FLOOR MOUNTED, "WR" INDICATES WEATHER RESISTANT RATED, "H" INDICATED HORIZONTALLY MOUNTED, "USB" INDICATES DUPLEX

20 AMP QUADRAPLEX (DOUBLE DUPLEX) - NOTES SAME AS ABOVE

RECEPTACLE WITH 2-PORT USB CHARGER

SPECIAL PURPOSE OUTLET OR EQUIPMENT CONNECTION - COORDINATE LOCATION AND TYPE OF CONNECTION

WITH EQUIPMENT BEING SERVED.

JUNCTION BOX WITH COVER MOTOR - SIZE AS INDICATED - COORDINATE W/ ACTUAL EQUIPMENT BEING SERVED

MANUAL STARTER - COORDINATE WITH EQUIPMENT BEING SERVED SINGLE THROW

FUSED DISCONNECT SWITCH - NEMA ENCLOSURE AS REQUIRED REMOTE CONTROL

MAGNETIC STARTER - COORDINATE W/ EQUIPMENT BEING SERVED

FUSED DISCONNECT SWITCH / MAGNETIC STARTER - NOTES SAME AS ABOVE

ADA ELECTRICALLY-ASSISTED DOOR OPENER PUSHBUTTON

BRANCH CIRCUIT RUN IN CEILING OR IN WALLS —— – LOW VOLTAGE OR CONTROL WIRING - #12 MINIMUM OR AS NOTED

— # MULTI-CONDUCTOR BRANCH CIRCUIT - NUMBER OF HASHMARKS IS NUMBER OF WIRES

(NOT INCLUDING GROUND WIRE) WITHOUT HASHMARKS IS TWO WIRE HOMERUN TO CIRCUIT AND PANEL INDICATED - NUMBER OF ARROWS IS NUMBER OF PHASE WIRES

NUMBER OF WIRES AS INDICATED ABOVE

PANELBOARD NAME - # INDICATES CIRCUIT HOMERUN

PANELBOARD NAME - #,RELAY # INDICATES CIRCUIT HOMERUN VIA INDICATED RELAY

── CONTINUATION OF CIRCUIT

→ DIRECTIVE ARROW

PANELBOARD - SEE PANELBOARD SCHEDULE(S)

COMMUNICATION WALL MOUNTED AT TYPICAL GENERAL PURPOSE ELECTRICAL OUTLER HEIGHT (18" AF TO CENTER). REFER

TO FLOOR PLANS, OUTLET CONFIGURATION DETAIL & TABLE ON E-501. COMMUNICATION WALL PHONE MOUNTED AT 48" AFF. TO CENTER. REFER TO FLOOR PLANS, OUTLET CONFIGURATION DETAIL

COMMUNICATION WIFI CEILING OUTLER WITH A 20' SERVICE LOOP. REFER TO FLOOR PLANS, OUTLET CONFIGUREATION

COMMUNICATION TV MOUNTED AT DISPLAY HEIGHT (72" AFF. TO CENTER). REFER TO FLOOR PLANS, OUTLET CONFIGUREATION DETAIL & TABLE ON E-501.

VIDEO TELECONFERENCING / AUDIO VISUAL (VTC/AV) INFRASTRUCTURE BOX ABD CONDUIT BETWEEN BOXES. REFER TO PLANS AND ELEVATION DETAILS ON E-501.

RECESSED FLOOR OR CEILING MOUNTED BOX - POWER & COMMUNICATIONS AS SHOWN-"F" INDICATES FLOOR MOUNTED, "C" INDICATES CEILING MOUNTED - REFER TO FLOOR PLANS & OUTLET CONFIGURATION DETAIL ON E-501.

CEILING ROUND SPEAKER (SOUND OR INTERCOM SYSTEM AS SHOWN)

CEILING 2x2 LAY-IN SPEAKER (SOUND OR INTERCOM SYSTEM AS SHOWN)

WALL SPEAKER (SOUND OR INTERCOM SYSTEM AS SHOWN)- "H" INDICATES HORN TYPE

MICROPHONE

INTERCOM SYSTEM CALL STATION

INTERCOM SYSTEM CONTROL PANEL

TELEPHONE/INTERCOM SYSTEM HAND SET

EMERGENCY PULL STATION

CABLE TRAY

LADDER TRAY

FIRE ALARM SYSTEM CONTROL PANEL

FIRE ALARM ANNUNCIATOR

FIRE ALARM SYSTEM CEILING MOUNTED HEAT DETECTOR

FIRE ALARM SYSTEM CEILING MOUNTED SMOKE DETECTOR FIRE ALARM SYSTEM CEILING MOUNTED CARBON MONOXIDE DETECTOR

FIRE ALARM SYSTEM CEILING MOUNTED COMBINATION HEAT & SMOKE DETECTOR

FIRE ALARM SYSTEM DUCT MOUNTED SMOKE DETECTOR

WALL MOUNTED FIRE ALARM SYSTEM MANUAL PULL STATION FIRE ALARM SYSTEM WALL MOUNTED AUDIO/VISUAL DEVICE WITH VISUAL DEVICE CANDELA RATING AS NOTED

FIRE ALARM SYSTEM WALL MOUNTED AUDIO DEVICE

FIRE ALARM SYSTEM WALL MOUNTED VISUAL DEVICE ONLY - CANDELA RATING AS NOTED FIRE ALARM SYSTEM

DOOR HOLD-OPEN DEVICE CONNECTION FIRE ALARM SYSTEM/SPRINKLER SYSTEM PRESSURE SWITCH

FIRE ALARM SYSTEM/SPRINKLER SYSTEM FLOW SWITCH

FIRE ALARM SYSTEM/SPRINKLER SYSTEM TAMPER SWITCH

SECURITY ALARM SYSTEM CONTROL PANEL SECURITY ALARM SYSTEM CAMERA - "IP" INDICATES IP CAMERA LOCATION, ALL OTHERS SHALL BE ANALOG

CAMERA, "V" INDICATES VANDAL RESISTANT, "WP" INDICATES WEATHERPROOF

			LIGI	HT FIXTUF	RE SCH	EDULE				
TYPE	DESCRIPTION	SIZE	MANUFACTURER CAT. NO.	LENS/LOUVER	LAMPS (1)	DRIVER (1)	MINIMUM EFFICACY	WATTS PER FIXTURE	VOLT.	NOTES
Α	CEILING RECESSED ARCHITECTURAL TROFFER	2'X2'	LEDALITE 4122-D1-ST-L-8A-E-S-7-D		LED	0-10V DIMMING	120	26	MVOLT	
A1	CEILING RECESSED ARCHITECTURAL TROFFER	2'X2'	LEDALITE 4122-D1-ST-L-8A-D-S-7-D		LED	0-10V DIMMING	117	34	MVOLT	
В	CEILING SURFACE LINEAR STRIP	4'L	DAY-BRITE FSS-4-30L-840-UNV-LSXR10		LED		119	26	MVOLT	
B1	CEILING SURFACE LINEAR STRIP	4'L	DAY-BRITE FSS-4-40L-840-UNV		LED		133	31	MVOLT	
С	CEILING RECESSED DETENTION GRADE	1'X4'	KENALL RMCA-4-FL/SA-0-1-45L40K-DCC-DV-2/TG-WL		LED	DIMMING	59	50	MVOLT	
D	ROOM IN USE LIGHT		KENALL METMSU-MW-R-IUDT-TR		LED				MVOLT	
F	SURFACE MOUNTED DETENTION GRADE	1'X4'	KENALL SCT-4-0-67L40K-DCC-DV-6-1		LED	DIMMING	84	67	MVOLT	
G	CEILING RECESSED DETENTION GRADE	2'X2'	KENAL RMCD-2-0-45L40K-DCC-DV-2/TG		LED	DIMMING	73	51	MVOLT	
Ø Ø	EXIT SIGN		KENALL METSW-MW-R-DT-EL		RED LED			1	MVOLT	REFER TO PLANS FOR QUANTITIES AND NUMBER
1 ▼ ^{X1}	EXIT SIGN - DETENTION GRADE		KENALL MMEX-1-**-R-DT-EL		RED LED			1	MVOLT	REFER TO PLANS FOR QUANTITIES AND NUMBER
4EB	EMERGENCY BATTERY PACK		KENALL METELHC-**-MW-2-6.5L-DT		LED				120VAC/12VDC	HIGH IMPACT CONSTRUCTION. ** CONTRACTOR TO DETERMINE BATTERY CAPACITY, 24N OR 40N.
1	EMERGENCY REMOTE HEAD		KENALL METER-MW-1-6.5L-12VAC/DC		LED				12VDC	HIGH IMPACT CONSTRUCTION.

LEGEND CONTINUED:

REQUEST TO EXIT

SECURITY ALARM SYSTEM MOTION DETECTOR SECURITY ALARM SYSTEM SIREN/STROBE

ACCESS CONTROL SYSTEM CARD READER

KEY PAD

ACCESS CONTROL POSITION SWITCH

ACCESS CONTROL SYSTEM ARMING STATION

DURESS LIGHT DURESS BUTTON

GENERAL NOTES:

ACCESSIBLE CEILING SPACE.

1. ALL WORK SHALL BE INSTALLED IN A NEAT AND WORKMAN LIKE MANNER, RECTILINEAR TO BUILDING STRUCTURE, AND IN ACCORDANCE WITH ALL APPLICABLE CODES, INCLUDING, BUT NOT LIMITED TO NFPA 70, 90A, 101 AND DIRECTION OF AUTHORITY HAVING JURISDICATION.

2. EXACT LOCATION OF MECHANICAL EQUIPMENT THAT REQUIRES ELECTRICAL CONNECTION IS SHOWN ON THE MECHANICAL PLANS.

3. CONTRACTOR SHALL REVIEW ALL TRADES CONTRACT DOCUMENTS, AND FIELD VERIFY TO DETERMINE SPECIFIC MOUNTING LOCATIONS FOR ELECTRICAL EQUIPMENT AND CONDUITS.

4. COORDINATE ARRANGEMENT, MOUNTING, AND SUPPORT OF ELECTRICAL CONDUIT AND EQUIPMENT TO PROVIDE FOR EASE OF DISCONNECTING THE EQUIPMENT WITH MINIMUM INTERFERENCE TO OTHER INSTALLATIONS; TO ALLOW RIGHT OF WAY FOR PIPING INSTALLED AT A REQUIRED SLOPE; AND SO CONNECTING RACEWAYS SHALL BE CLEAR OF OBSTRUCTIONS AND OF THE WORKING AND ACCESS SPACE OF OTHER EQUIPMENT.

5. RUN SEPARATE NEUTRAL WIRE FOR EACH DEDICATED BRANCH CIRCUIT SHOWN ON THE PLANS.

6. DEVICES SHALL NOT BE INSTALLED BACK-TO-BACK IN ADJACENT ROOMS. ADJUST LOCATIONS AS NECESSARY TO AVOID THIS CONDITION.

7. PROVIDE MINIMUM 1" CONDUIT FOR COMMUNICATION OUTLETS UP TO

ABBREVIATIONS:

FIN

FLR

ABOVE FINISHED FLOOR HORSEPOWER, HEAT PUMP JUNCTION BOX ABOVE FINISHED GRADE ATS AUTOMATIC TRANSFER SWITCH KVA KILO VOLT AMPS BATT KILOWATT(S) BKR BREAKER LTG LIGHTING BUILDING BLDG MAXMAXIMUM CIRCUIT BREAKER MINIMUM NEW ON CENTER CMP CENTRAL MAINE POWER CO. OWNER SUPPLIED, OWNER INSTALLED ITEM PARTIAL CIRCUIT CT CURRENT TRANSFORMER POLYVINYL CHLORIDE RECEPTACLE

DRAWING EMERGENCY ELECTRICAL METALLIC TUBING **EQUIPMENT** FIRE ALARM FIRE ALARM ANNUNCIATOR FIRE ALARM CONTROL PANEL

FINISH, FINISHED

FLOOR

FIRE ALARM SYSTEM POWER EXTENDER

UNDERGROUND VOLTS WIRE GUARD WM WIREMOLD WEATHERPROOF

TELEPHONE

TYPICAL

0 75% CONSTRUCTION DOCUMENTS 12.17.19 DESCRIPTION

WWW.WBRCAE.COM BANGOR, MAINE 207-947-4511 PORTLAND, MAINE 207-828-4511 SARASOTA, FLORIDA 941-556-0757 **40A MANSON LIBBY ROAD GSA FITOUT**

40 MANSON LIBBY ROAD SCARBOROUGH, ME 04074

ELECTRICAL LEGEND AND LIGHT FIXTURE SCHEDULE

WBRC CAD FILE: 4290.00-E-001 4290.00 GRAPHIC SCALE: AS INDICATED

SHEET TITLE:

CHECKED BY:

PROJECT MANAGER DRAWN BY:

2021-ICLI-00025 349

E-001 ELECTRICAL LEGEND

GENERAL DEMO NOTES:

UNLESS OTHERWISE NOTED, ALL EXISTING PANELS, LIGHTING, RECEPTACLES AND DEVICES SHOWN ON THIS PLAN ARE TO BE DISCONNECTED AND REMOVED.

TECHNICAL NOTES:

UNLESS OTHERWISE NOTED, ALL EXISTING LIGHTING, RECEPTACLES AND DEVICES IN THIS AREA ARE TO BE DISCONNECTED AND REMOVED.

EXISTING PANEL TO BE DISCONNECTED AND REMOVED. FEEDERS TO BE REMOVED BACK TO

② EXISTING POWER AND CONTROLS FOR OVERHEAD DOOR TO BE DISCONNECTED AND REMOVED.

0 75% CONSTRUCTION DOCUMENTS 12.17.19
REV. DESCRIPTION DATE

WWW.WBRCAE.COM BANGOR, MAINE 207-947-4511 PORTLAND, MAINE 207-828-4511 SARASOTA, FLORIDA 941-556-0757 **40A MANSON LIBBY**

ROAD GSA FITOUT 40 MANSON LIBBY ROAD SCARBOROUGH, ME 04074

FIRST FLOOR ELECTRICAL REMOVALS PLAN

WBRC CAD FILE: 4290.00-ED101

4290.00 GRAPHIC SCALE: 1/4" = 1'-0" PROJECT MANAGER:

SHEET TITLE: PROJECT No. PROJECT MANAGER: DRAWN BY: CHECKED BY:

LIGHTING CONTROL KEYED NOTES:

CEILING MOUNTED OCCUPANCY SENSOR(S) WITH AUTO ON/OFF CONTROL.

MANUAL ON / AUTO OFF WALL SWITCH MOUNTED VACANCY SENSOR.

GEILING MOUNTED OCCUPANCY SENSOR(S) WITH MANUAL ON / AUTO OFF CONTROL.

CEILING MOUNTED OCCUPANCY SENSOR(S) WITH WALL DIMMER SWITCHES / AUTO OFF.

0 75% CONSTRUCTION DOCUMENTS 12.17.19
REV. DESCRIPTION DATE



PROJECT NORTH

CONSTRUCTION

A R C H I T E C T S • E N G I N E E R S


WWW.WBRCAE.COM
BANGOR, MAINE 207-947-4511
PORTLAND, MAINE 207-828-4511
SARASOTA, FLORIDA 941-556-0757

40A MANSON LIBBY ROAD GSA FITOUT 40 MANSON LIBBY ROAD SCARBOROUGH, ME 04074

FIRST FLOOR LIGHTING PLAN


WBRC CAD FILE: 4290.00-EL101 4290.00 GRAPHIC SCALE:


1/4" = 1'-0"

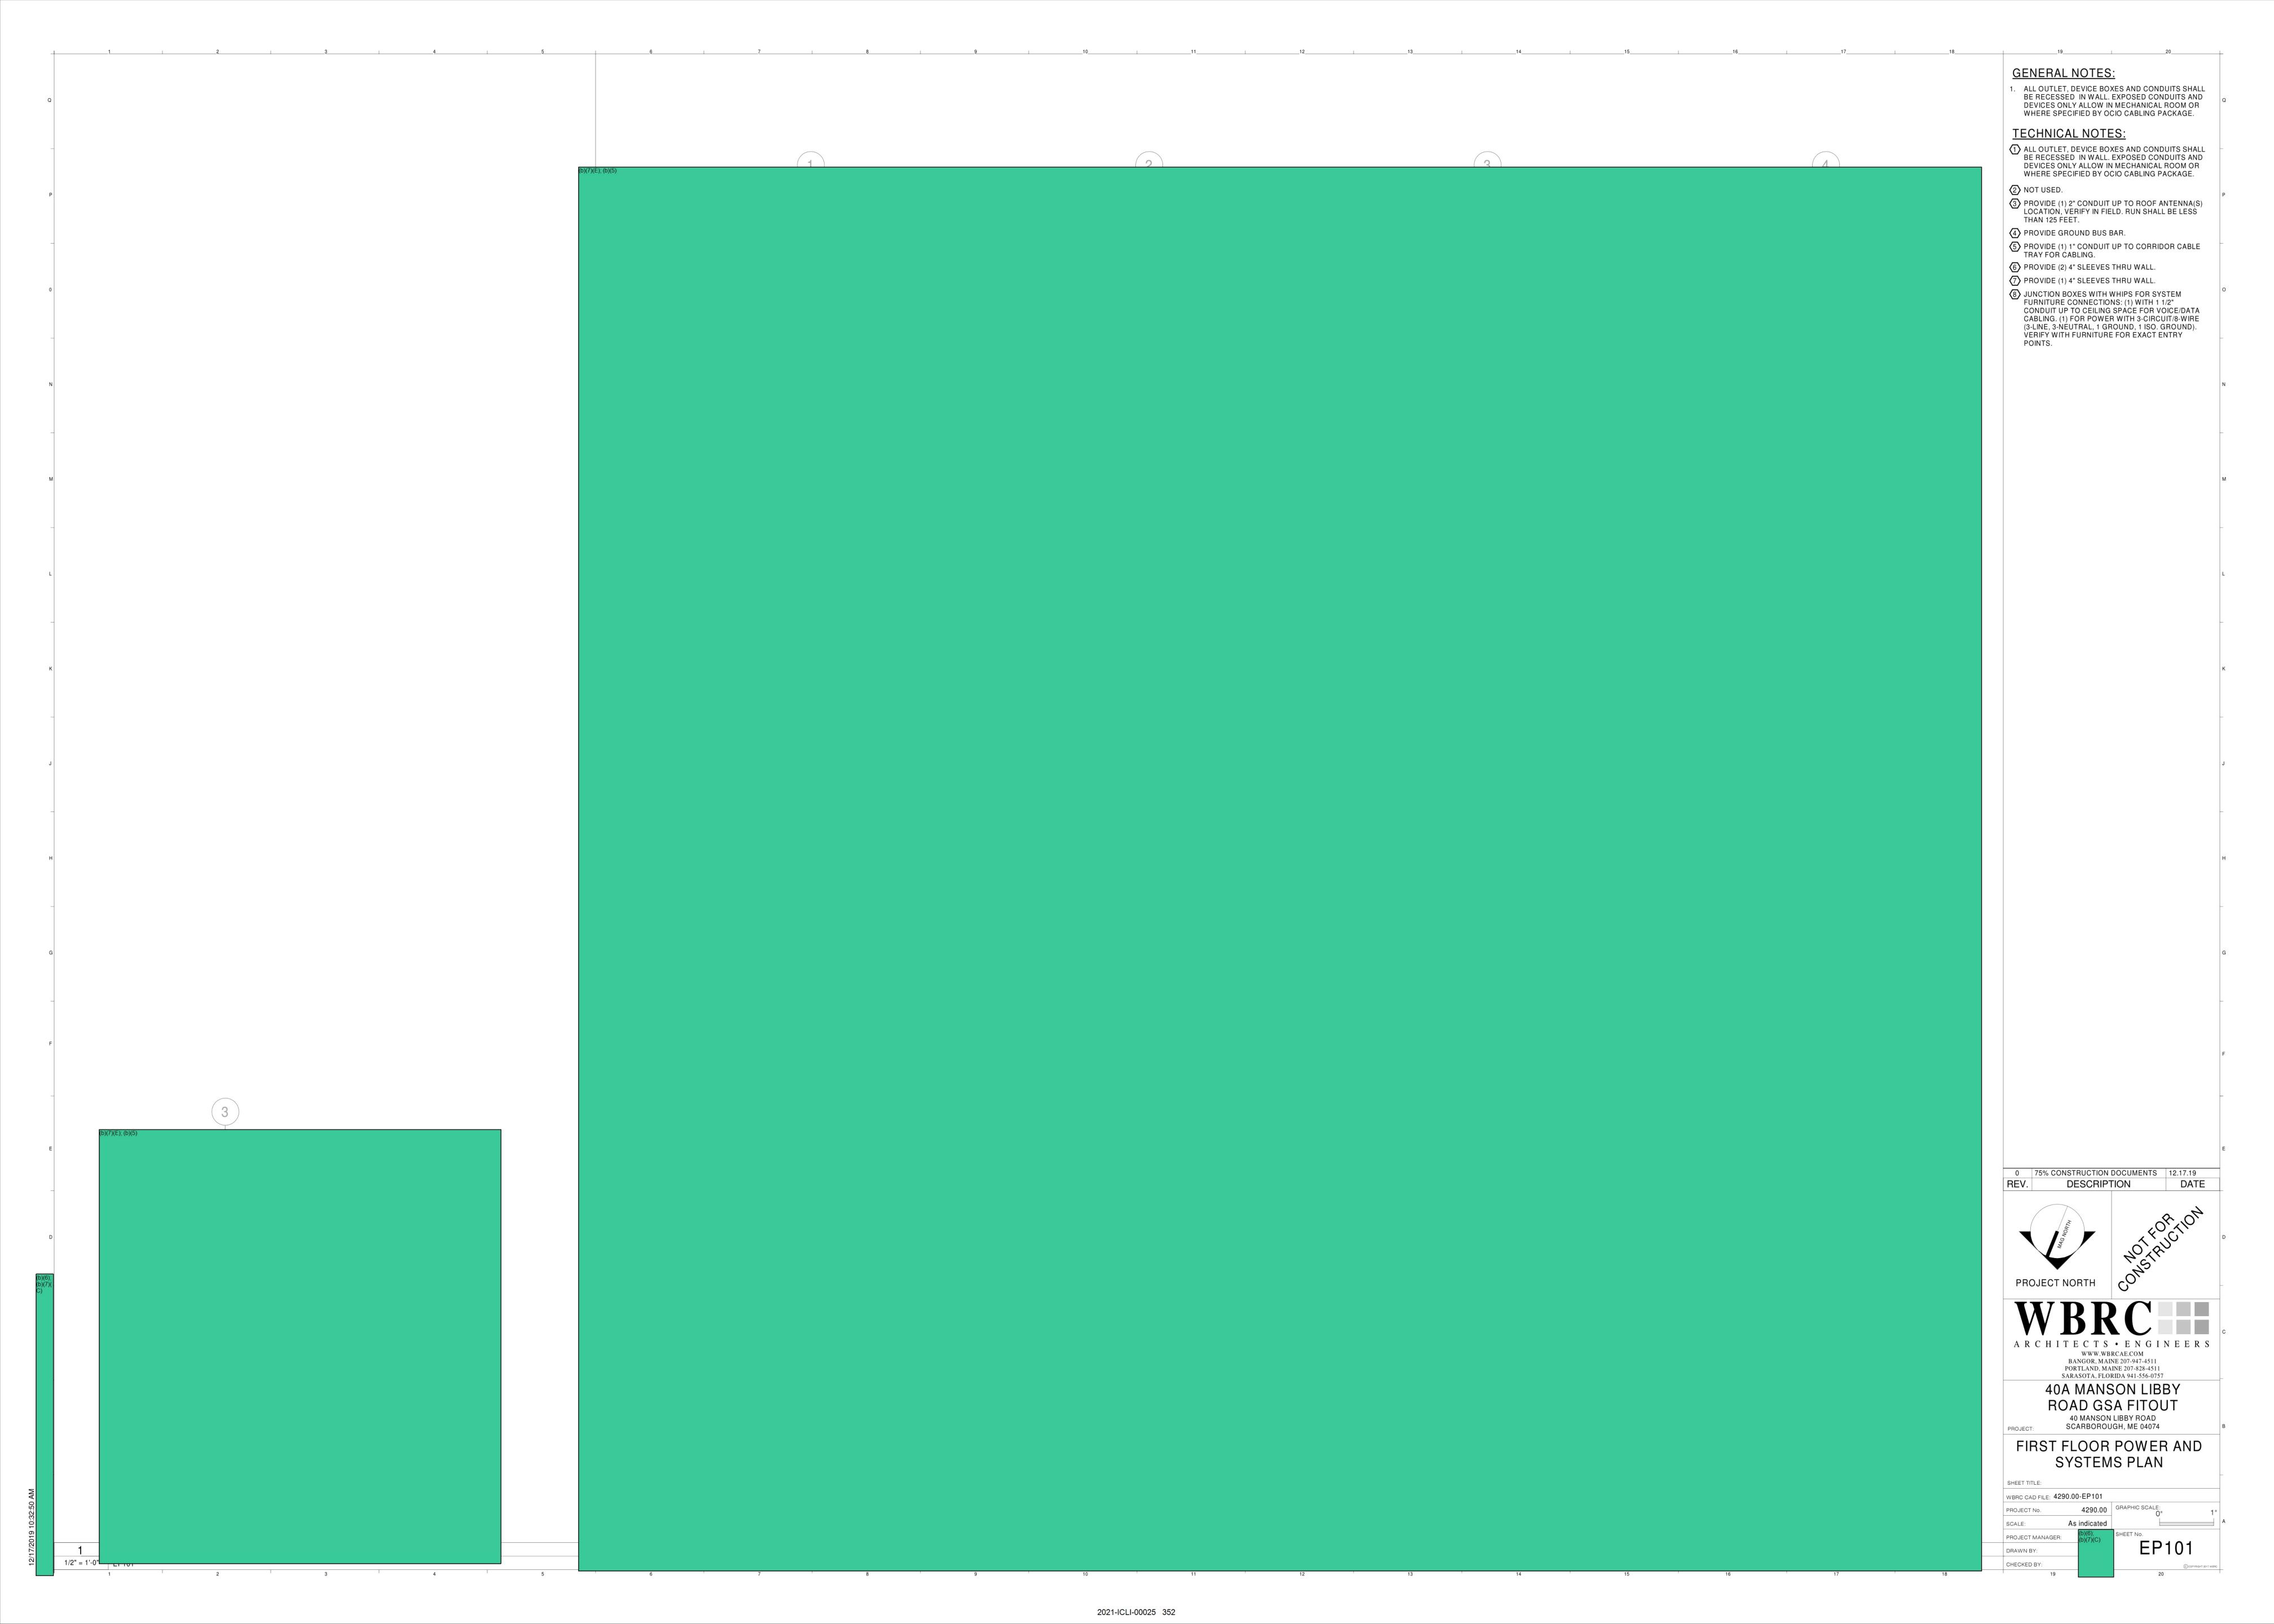


PANEL					LP1					
VOLTAGE: 120/208V		PHASES: 3		WIRE	: 4	TYPE	:			LOCATION: MECH/ELEC 121
200A MCB SERVICE	KW	BRKR	FED F	ROM: NO	PHASE	NO	NOTE	BRKR	KW	MOUNTING: SURFACE SERVICE
REC - BULK STOR. 116, (b)(7)(E)	1.0	1P20	NOTE	1	A	2	NOTE	1P20	0.6	REC - (b)(7)(E)
REC - 117, 118, 124, 125	1.4	1P20		3	В	4		1P20	0.4	P-3 - MECH/ELEC 121
REC - MAT FITNESS 112	1.2	1P20		5	С	6		1P20	1.2	REC - CORR 106, PROC 119, PROP 120
WATER COOLER	1.0	1P20		7	A	8		1P20	0.8	REC - MENS & WOMENS 109 & 110
REC - CONF. 107, ALIEN FILES 108	1.0	1P20		9	В	10		1P20	1.0	REC MANAGER 105, CONF. 107
REC - OFFICE 104, MANAGER 105	1.2	1P20		11	С	12		1P20	1.2	REC (b)(7)(E) OFFICE 104
REC - 100, 101, 102, 103, 106	1.2	1P20		13	A	14		1P20	1.4	REC - LOBBY 101, SUPPLY 126
REC - CORR. 106, STAGING 128	1.4	1P20		15	В	16		1P20	1.4	REC - STAGING 128, BREAK RM 129
REC - BREAK ROOM 129	0.6	1P20		17	С	18		1P20	1.2	REC - MICROWAVE BREAK RM 129
REC - SUPPORT 127	1.4	1P20		19	A	20		1P20	0.4	REC - MECH/ELEC 121, INTERVIEW 122
REC (b)(7)(E)	1.2	1P20		21	В	22		1P20	1.2	EF-1 ON ROOF
OPEN OFFICE 125 - SYSTEMS FURNITURE	0.8	1P20		23	С	24		1P20	1.0	OPEN OFFICE - SYSTEMS FURNITURE
OPEN OFFICE 125 - SYSTEMS FURNITURE	0.8	1P20		25	A	26		1P20	1.0	OPEN OFFICE - SYSTEMS FURNITURE
OPEN OFFICE 125 - SYSTEMS FURNITURE	0.8	1P20		27	В	28		1P20	1.0	OPEN OFFICE - SYSTEMS FURNITURE
EF-2 - RESTROOM 102	0.1	1P20		29	С	30		1P20	1.4	LTS-1XX-03,04,05,07,08,09,10,12,28,29,30
LTS-1XX-00,01,02,06,21,23,24,25,26,27	1.4	1P20		31	A	32		1P20	0.2	CUH-1, CUH -2
	4.0			33	В	34			4.0	
RTU-1	4.0	3P45		35	С	36		3P45	4.0	RTU-2
K10-1		- 51 45						31 43		K10-2
	4.0			37	A	38			4.0	
P-1 - MECH/ELEC 121	0.4	1P20		39	В	40		2P20	0.8	P-2 - MECH/ELEC 121
HWP-1 - MECH/ELEC 121	0.1	1P20		41	С	42		21 20	0.8	
SPARE		1P20		43	A	44		1P20		SPARE
SPARE		1P20		45	В	46		1P20		SPARE
SPARE		1P20		47	С	48		1P20		SPARE
SPARE		1P20		49	A	50		1P20		SPARE
SPARE		1P20		51	В	52		1P20		SPARE
SPARE		1P20		53	A	54		1P20		SPARE
SPACE				55	В	56				SPACE
SPACE				57	С	58				SPACE
SPACE				59	A	60				SPACE
SPACE				61	В	62				SPACE
SPACE				63	A	64				SPACE
SPACE				65	В	66				SPACE
SPACE				67	С	68				SPACE
SPACE				69	A	70				SPACE
SPACE				71	В	72				SPACE

PANEL					LP2	•				
VOLTAGE: 120/208V		PHASES: 3		WIRE	: 4	TYPE	:			LOCATION: MECH/ELEC 121
200A MCB			FED F	ROM:					7	MOUNTING: SURFACE
SERVICE	KW	BRKR	NOTE	NO	PHASE	NO	NOTE	BRKR	KW	SERVICE
LTS-113,114,115,116,117,118,119,120,122,131	1.5	1P20		1	A	2		1P20	1.0	DESK REC - PROC. 119, INTER. 122
SPECIAL PURPOSE - IT/LAN 130		1P30		3	В	4		1P30		SPECIAL PURPOSE - IT/LAN 130
SPECIAL PURPOSE - IT/LAN 130		1P30		5	С	6		2020		CDECIAL DUDDOCE IT /I ANI 120
REC - IT/LAN 130	1.4	1P20		7	A	8		2P30		SPECIAL PURPOSE - IT/LAN 130
REC - IT/LAN 130	1.6	1P20		9	В	10		1P20	0.8	OVERHEAD QUAD - IT/LAN 130
ACCULLON POOE	1.4	2020		11	С	12		1P20		EMERGENCY BATTERY UNITS
ACCU-1 ON ROOF	1.4	2P20		13	A	14		1P20		EXIT SIGNS
				15	В	16				
				17	С	18				
				19	A	20				
				21	В	22				
				23	С	24				
				25	A	26				
				27	В	28				
				29	С	30				
				31	A	32				
				33	В	34				
				35	С	36				
				37	A	38				
				39	В	40				
				41	С	42				

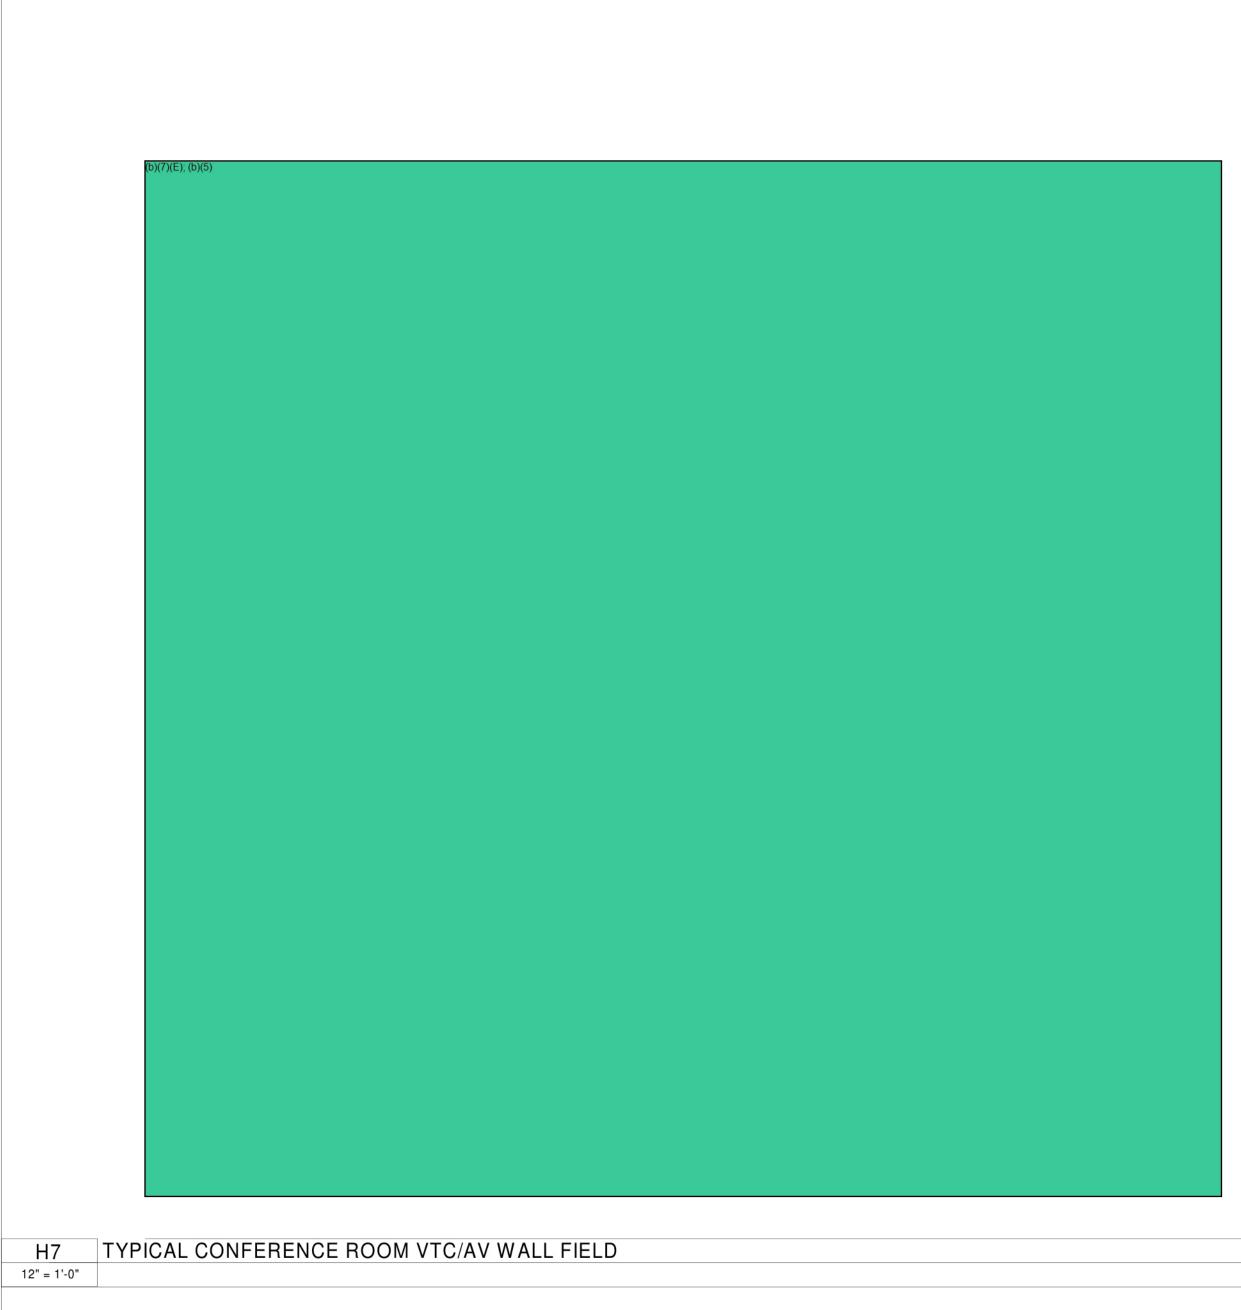

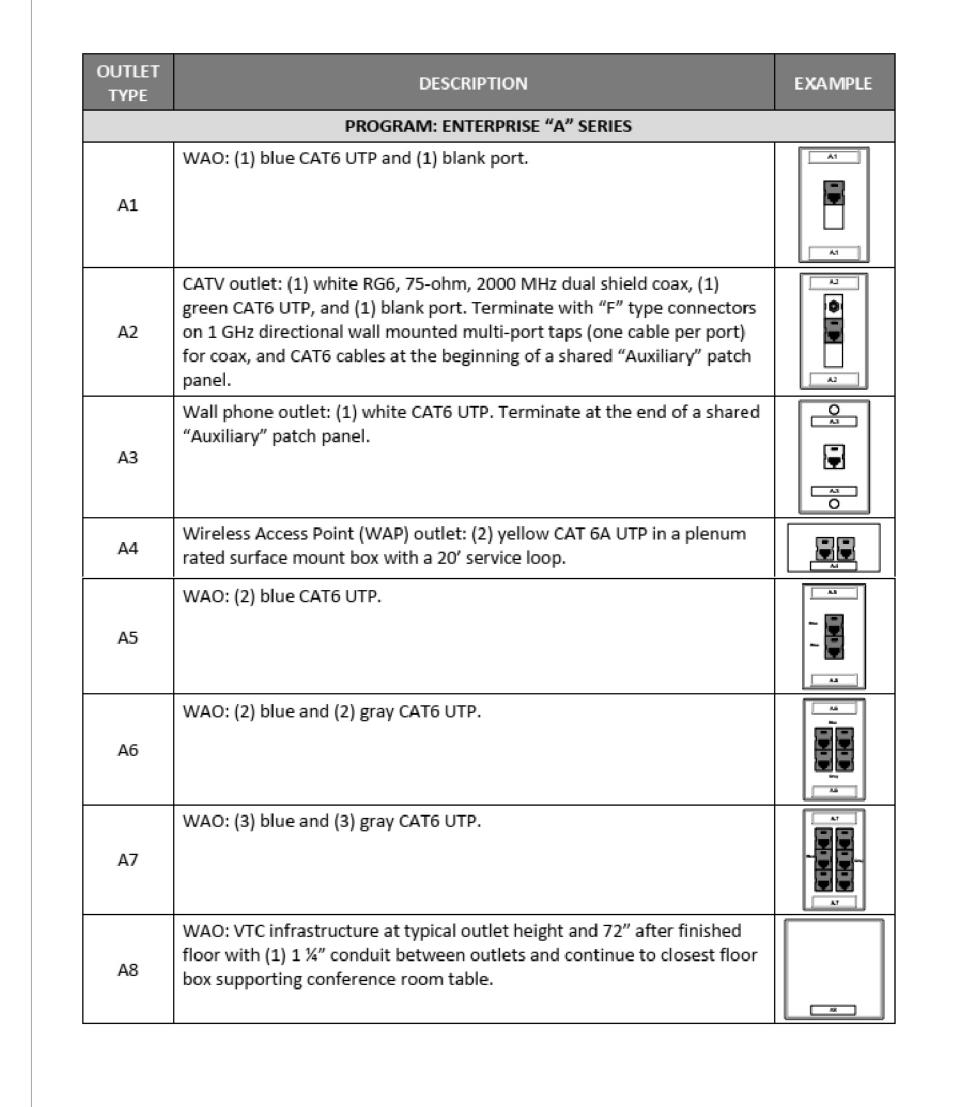

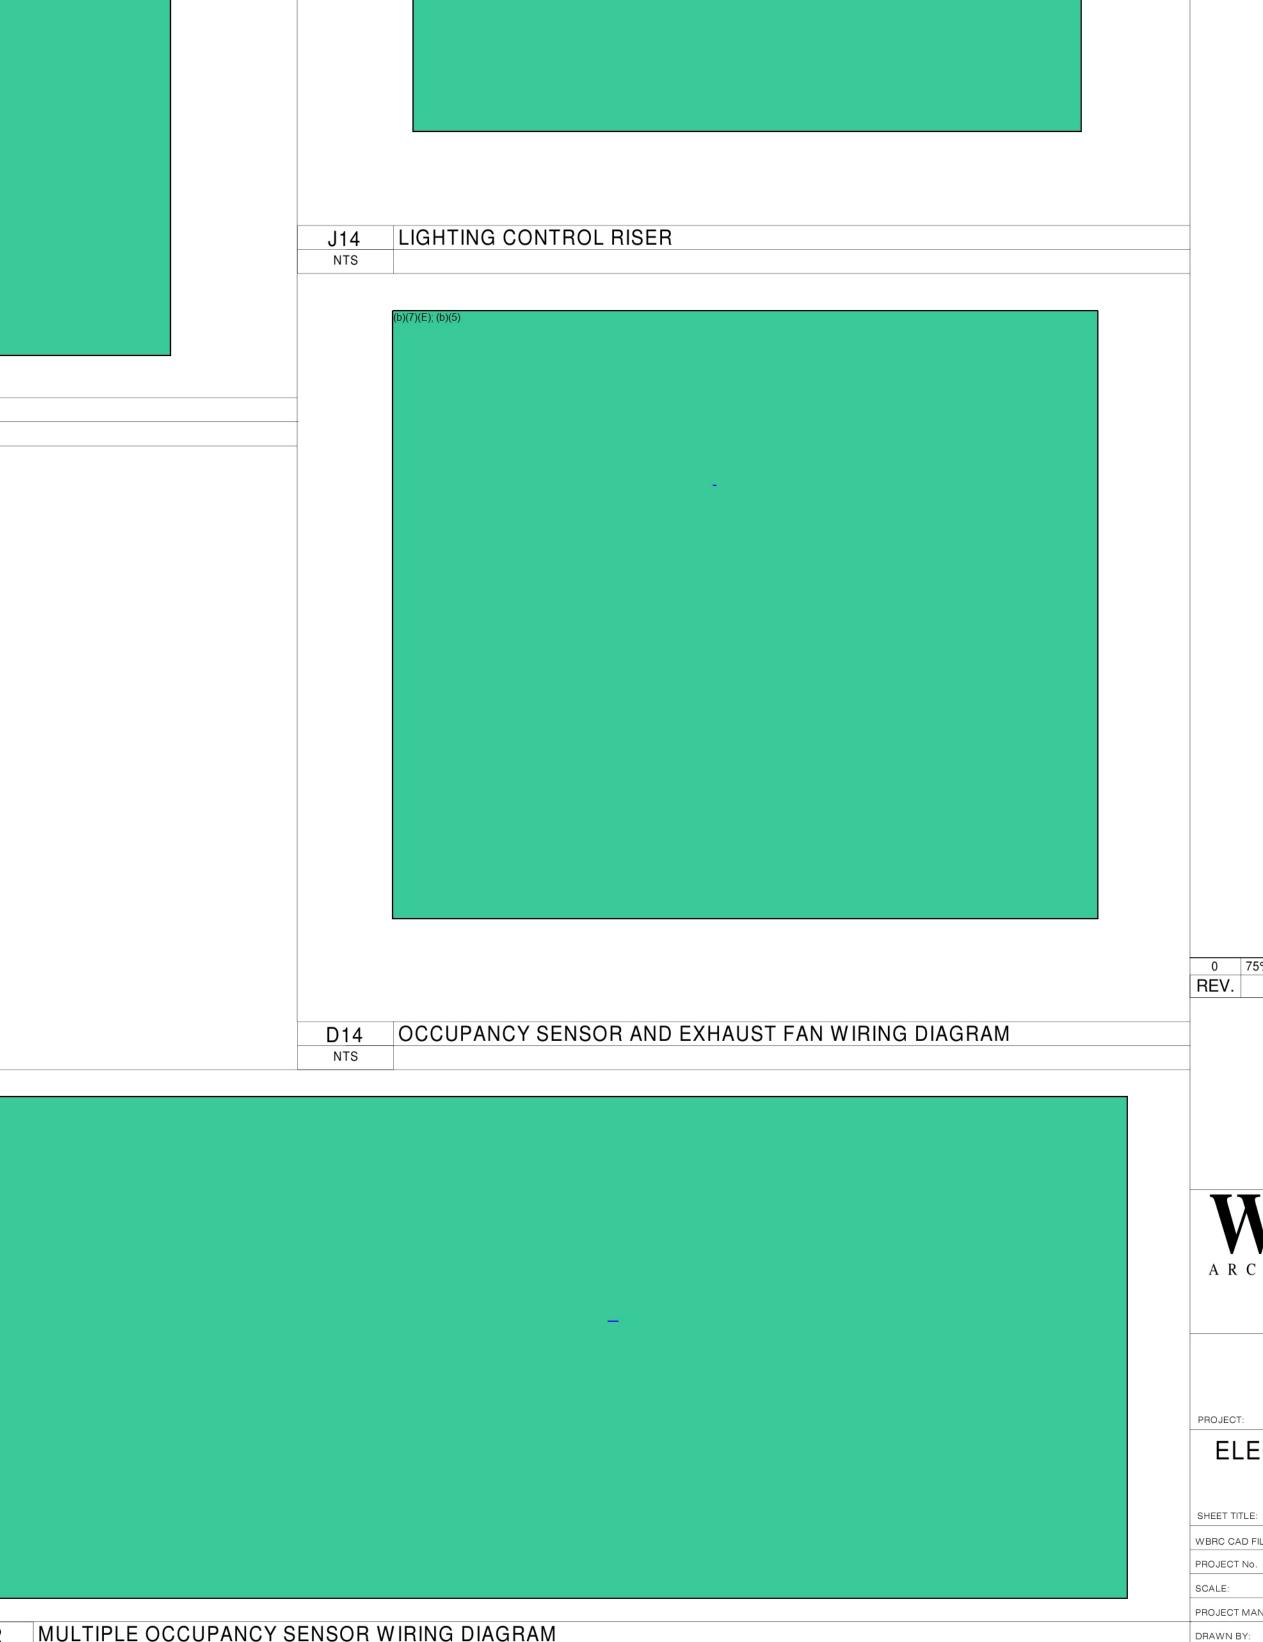

1 ELECTRICAL 1-LINE DIAGRAM

0 75% CONSTRUCTION DOCUMENTS 12.17.19
REV. DESCRIPTION DATE WWW.WBRCAE.COM BANGOR, MAINE 207-947-4511 PORTLAND, MAINE 207-828-4511 SARASOTA, FLORIDA 941-556-0757 **40A MANSON LIBBY** ROAD GSA FITOUT 40 MANSON LIBBY ROAD SCARBOROUGH, ME 04074

ELECTRICAL DETAILS AND SCHEDULES

WBRC CAD FILE: 4290.00-E-501

A7 COMMUNICATION OUTLET CONFIGURATION DETAILS & CABLING REQUIREMENTS

A12 MULTIPLE OCCUPANCY SENSOR WIRING DIAGRAM

As indicated PROJECT MANAGER: CHECKED BY:

From: (b)(6); (b)(7)(C)

Sent: 11 Sep 2019 17:54:26 +0000

To: (b)(6); (b)(7)(C)

(b)(6); (b)(7)(C)

Subject: ERO Scarborough ME-PRO-13-ERO-0293- DIDs review

Attachments: __DID Review Comment Responses.pdf, _2019.08.23 - AE101 - First Floor Partial

Removal & New Work Plans.pdf, ICE - ERO Scarbourough ME Project Schedule .xlsx, ICE-ERO

Scarborough - Annotated Room Data Sheets.pdf

Importance: High

Also attached new file from Architect's lessor Annotated Room Data Sheets.

Attached an updated project schedule that will be adjusted as we go through the project. If there are any questions or concerns please let me know.

To all,

You are invited to participate in a conference call coordination meeting for the subject project above, and to review latest submission from Architect's lessor.

To gain access, please call Conference Call #: 1-866-707 (b)(7)(C)

Participant Passcode #
(b)(6);
(b)(7)(C)

at the prescribed time.

Please feel free to forward this email to anybody else that needs to join the meeting. Your feedback is very important to us.

Do not hesitate to contact me if you have any questions. Attached documents for our meeting.

Thank you,

(b)(6); (b)(7)(C)

MA. NCARB. SAME. Intl. Assoc. AIA.
OAFM Project Manager
Office of Asset and Facilities Management (OAFM)
FMD|OAFM|DHS|ICE


500 12th Street SW. (b)(6); (b)(7)(C)

Washington, DC 20536

C: 202-754 (b)(6); (b)(7)(C)





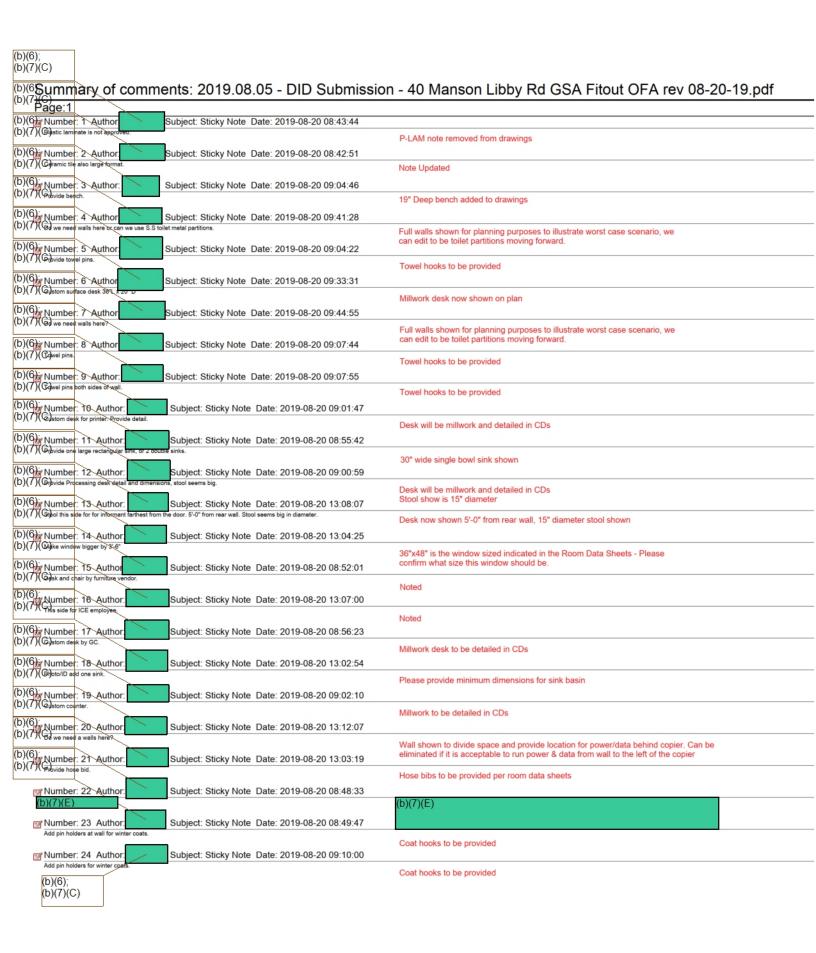

GENERAL REMOVAL NOTES:

1. GENERAL CONTRACTOR (GC) SHALL FIELD VERIFY & REPORT EXISTING CONDITIONS AND DIMENSIONS PRIOR TO REMOVALS. IF DISCREPANCIES ARE FOUND. GC TO NOTIFY ARCHITECT FOR CLARIFICATION BEFORE COMMENCING WITH THE WORK.

2. GC AND SUBCONTRACTORS (SC) FOR EACH TRADE ARE ADVISED THAT INFORMATION PERTINENT TO THEIR WORK MAY BE INDICATED OR DESCRIBED IN OTHER PORTIONS OF THE

3. REFER TO SPECIFIC DRAWINGS FOR PLUMBING, HVAC AND ELECTRICAL REMOVALS

4. GC AND SC ARE RESPONSIBLE FOR PROVIDING ALL REMOVALS AND PATCHING REQUIRED TO COMPLETE THEIR WORK IN ACCORDANCE WITH THE DESIGN INTENT.

5. THESE REMOVALS DRAWINGS HAVE BEEN PREPARED BASED UPON EXISTING CONSTRUCTION DOCUMENT DRAWINGS AND FIELD OBSERVATIONS. THE EXACT LOCATION OF THE BUILDING STRUCTURAL ELEMENTS (COLUMNS, BEAMS, LOAD BEARING WALLS, ETC.) MAY BE DIFFERENT IN THE FIELD THAN WHAT IS INDICATED OR ASSUMED ON THESE DRAWINGS. GC SHALL FIELD VERIFY THE LOCATION OF ALL BUILDING STRUCTURAL ELEMENTS. ALL BUILDING STRUCTURAL ELEMENTS SHALL REMAIN UNLESS INDICATED TO BE REMOVED ON THE STRUCTURAL DRAWINGS. ANY BUILDING STRUCTURAL ELEMENT INDICATED AS BEING REMOVED ON THIS DRAWING SHALL BE CONFIRMED WITH THE ARCHITECT PRIOR TO COMMENCING

6. PROVIDE NEW LINTELS AT NEW OPENINGS IN EXISTING WALLS. SEE STRUCTURAL DRAWINGS FOR INFORMATION ON LINTELS. IF NEW LINTEL IS NOT INDICATED, NOTIFY ARCHITECT FOR DIRECTION PRIOR TO PROCEEDING.

7. GC SHALL PROTECT, REPLACE OR REPAIR ANY EXISTING CONSTRUCTION SCHEDULED TO REMAIN WHICH IS DAMAGED DURING REMOVALS

8. GC SHALL PROVIDE REQUIRED SHORING OR TEMPORARY BRACING DURING REMOVALS 9. REMOVE EXISTING CEILINGS AND SUPPORTS WHERE NEW CEILINGS ARE SCHEDULED IN THE ROOM FINISH SCHEDULE.

10. REMOVE PARTITIONS, SHELVING, CABINETRY AND ALL MISCELLANEOUS ITEMS SHOWN WITH DASHED LINES.

11. PATCH ALL FLOORS, WALLS, BASE AND CEILINGS WHERE PARTITIONS OR MISCELLANEOUS ITEMS ARE REMOVED.

12. REMOVE DOORS, FRAMES AND SIDELIGHTS SHOWN WITH DASHED LINES, UNLESS OTHERWISE NOTED.

13. REMOVE TOILET PARTITIONS AND GRAB BARS SHOWN WITH DASHED LINES. REPAIR EXISTING CONSTRUCTION SCHEDULED TO REMAIN.

SCHEDULE. PREPARE EXISTING FLOOR SURFACES TO RECEIVE NEW FLOORING. 15. CONTRACTOR SHALL VERIFY WITH THE OWNER THOSE REMOVED ITEMS TO BE TURNED OVER TO THE OWNER.

14. REMOVE EXISTING FLOORING WERE NEW FLOORING IS SCHEDULED IN THE ROOM FINISH

								FINISH	SCHEDULE				
	ROOM	FLOOR				W	ALLS			MILLWOR	K	CEILING	
NUMBER	R NAME	FIELD	ACCENT 1	BASE FINISH	NORTH	EAST	SOUTH	WEST	CABINET	COUNTERTOP	OTHER	FINISH	COMMENTS
100	VEST	PT		CT	P-1	P-1	P-1	P-1				ACT	
101	LOBBY	CPT-T		VWB	P-1	P-1	P-1	P-1				ACT	
102	RESTROOM	PT		CT	CT/P-1	CT/P-1	CT/P-1	CT/P-1				GYP	CT TO 6'-0" AF.F.
(b)(7)(E)		СРТ-Т		VWB	P-1	P-1	P-1	P-1				ACT	
104	SDDO OFFICE	CPT-T		VWB	P-1	P-1	P-1	P-1				ACT	
105	OCIO EAST MANAGER	CPT-T		VWB	P-1	P-1	P-1	P-1				ACT	
106	CORRIDOR	CPT-T		VWB	P-1	P-1	P-1	P-1				ACT	
107	CONFERENCE	CPT-T		VWB	P-1	P-1	P-1	P-1				ACT	
108	ALIEN FILE	CPT-T		VWB	P-1	P-1	P-1	P-1				ACT	
109	WOMENS	PT		CT	CT/P-1	CT/P-1	CT/P-1	CT/P-1	WD	SSURF		GYP	CT TO 6'-0" AF.F.
110	MENS	PT		CT	CT/P-1	CT/P-1	CT/P-1	CT/P-1	WD	SSURF		GYP	CT TO 6'-0" AF.F.
112	MAT FITNESS	RUBER MATS		VWB	P-1	P-1	P-1	P-1				ACT	PROVIDE PLYWOOD BACKUP FOR HANGING MATS UP TO 8'-0" AFF
(b)(7)(E)		EPOXY		CMU COVE	P-1 (E)	P-1 (E)	P-1 (E)	P-1 (E)			CONC. BENCH	MTL. PLANK	
		EPOXY		CMU COVE	P-1 (E)	P-1 (E)	P-1 (E)	P-1 (E)			CONC. BENCH	MTL. PLANK	
		EPOXY		CMU COVE	P-1 (E)	P-1 (E)	P-1 (E)	P-1 (E)			CONC. BENCH	MTL. PLANK	
116	BULK STORAGE	VTC		VWB	P-1	P-1	P-1	P-1				ACT	
117	MAN TRAP	EPOXY		CMU COVE	P-1 (E)	P-1 (E)	P-1 (E)	P-1 (E)				MTL. PLANK	
118	SALLY PORT	EPOXY		CMU COVE	P-1 (E)	P-1 (E)	P-1 (E)	P-1 (E)				N/A	
(b)(7)(E)		EPOXY		CMU COVE	P-1 (E)	P-1 (E)	P-1 (E)	P-1 (E)				MTL. PLANK	
120	PROP	EPOXY		CMU COVE	P-1 (E)	P-1 (E)	P-1 (E)	P-1 (E)				MTL. PLANK	
121	MECH/ELEC	VCT		VWB	P-1	P-1	P-1	P-1				ACT	
(b)(7)(E)		VCT		VWB	P-1	P-1	P-1	P-1				ACT	
		CONC. SEALED		VWB	P-1	P-1	P-1	P-1				GYP	SECURE GYPSUM BD CEILING
124	STAFF ENTRY	PT		CT	P-1	P-1	P-1	P-1				ACT	
125	OPEN OFFICE	CPT-T		VWB	P-1	P-1	P-1	P-1				ACT	
126	SUPPLY	CPT-T		VWB	P-1	P-1	P-1	P-1				ACT	
127	SUPPORT	CPT-T		VWB	P-1	P-1	P-1	P-1				ACT	
128	OCIO STAGING	CPT-T		VWB	P-1	P-1	P-1	P-1				ACT	
129	BREAK ROOM	LVT		VWB	P-1	P-1	P-1	P-1	WD	SSURF		ACT	
130	IT/LAN	ESD VINYL FLOORING		VWB	P-1	P-1	P-1	P-1				ACT	PROVIDE FR PLYWOOD BACKUP FOR MOUNTING IT EQUIPMENT
(b)(7)(E)		VCT		VWB	P-1	P-1	P-1	P-1				ACT	

KEYNOTES:

WALL LEGEND:

NEW WALL

FINISH NOTES:

CPT-T:

P-# (E):

WD:

EXISTING TO REMAIN

EXISTING TO BE REMOVED

ACOUSTIC PANEL CEILING

WOOD-LOOK VINYL PLANK

SOLID SURFACE/QUARTZ

MTL. PLANK: METAL SECURITY PLANK CEILING

VINYL WALL BASE

CARPET TILE

EPOXY PAINT

PAINTED GYPSUM BOARD CEILING

LARGE FORMAT CERAMIC TILE

LARGE FORMAT PORCELAIN TILE

WWW.WBRCAE.COM BANGOR, MAINE 207-947-4511 PORTLAND, MAINE 207-828-4511 SARASOTA, FLORIDA 941-556-0757

40 MANSON LIBBY ROAD **GSA FITOUT** 40 MANSON LIBBY ROAD SCARBOROUGH, ME 04074

FIRST FLOOR PARTIAL REMOVAL & NEW WORK

PLANS WBRC CAD FILE: 4290.00 - GSA DHS-ARCH_R19.rvt 4290.00 GRAPHIC SCALE: PROJECT No.

As indicated

DRAWN BY:

PROJECT MANAGER: CHECKED BY:

Boston Leasing- Building # Project # Lease #

O	£ £	Miles	L	C - L	

-	PHASE	DUE	DAYS*	1
	EXECUTED LEASE			,
1	Lease Award	Friday, April 26, 2019		
·	DID PHASE			
2	DID Kick off Meeting	Thursday, June 13, 2019	48	Days
2	DID Submission (1st Round)	Monday, July 8, 2019	25	Days
2	DID Comments (1st Round)	Monday, July 29, 2019	21	Days
2	DID Submission (2nd Round)	Monday, August 5, 2019	7	Days
2	DID Comments (2nd Round)	Tuesday, August 20, 2019	15	Days
2	DID Submission (3rd Round)	Tuesday, August 27, 2019	7	Days
2	DID Comments (3rd Round)	Thursday, September 5, 2019	9	Days
2	Final DID Submission	Tuesday, September 10, 2019	5	Days
2	GSA & Agency Review and Approval	Sunday, September 15, 2019	5	Days
	CD PHASE			
3	CD Submission (35%)	Sunday, September 15, 2019	0	Days
3	CD Comments (35%)	Sunday, September 15, 2019	0	Days
3	CD Submission (50%)	Sunday, October 13, 2019	28	Days
3	CD Comments (50%)	Sunday, November 3, 2019	21	Days
3	CD Submission (75%)	Wednesday, November 13, 2019	10	Days
3	CD Comments (75%)	Wednesday, December 4, 2019	21	Days
3	CD Submission (95%)	Saturday, December 14, 2019	10	Days
3	CD Comments (95%)	Saturday, January 4, 2020	21	Days
3	Final CD Submission (100%)	Saturday, January 11, 2020	7	Days
3	GSA & Agency Review Complete (DO NOT APPROVE)	Thursday, January 16, 2020	5	Days
	PRICING PHASE			
4	Pricing / TICS Submission (1st Round)	Thursday, February 13, 2020	28	Days
4	GSA Review and Comment (1st Round)	Sunday, February 23, 2020	10	Days
4	Pricing / TICS Submission (2nd Round)	Sunday, March 8, 2020	14	Days
4	GSA Review and Negotiation (2nd Round)	Wednesday, March 18, 2020	10	Days
4	Final Pricing Submission	Wednesday, April 1, 2020	14	Days
4	NTP Issued	Wednesday, April 8, 2020	7	Days
	CONSTRUCTION PHASE	,,,,,,,,,,,,,,,,,,,,,,,,,,,,,,,,,,,,,,,		
5	Construction Kickoff	Sunday, April 12, 2020	4	Days
	Inspection and Acceptance	Wednesday, July 1, 2020	80	Days
Ť	PHASE	COMPLETE	TOTAL	22,0
1	Lease Award	Friday, April 26, 2019	8	Days
	DID Phase	Sunday, September 15, 2019	142	Days
	CD Phase	Thursday, January 16, 2020	123	Days
	PRICING PHASE	Wednesday, April 8, 2020	83	Days
5	CONSTRUCTION PHASE	Wednesday, July 1, 2020	84	Days
J	OCNOTIVO HON FHASE	Twednesday, July 1, 2020	440	
			440	Days

NOTES:

* If line is not required for project, enter "0" for days.

**

Exhibit D



Facility Design Guide
Annotated to reflect 10%
DID scope agreed to
by GSA/DHS/ICE and MRA

OS

COM-ITC-RWC IT/Telecom Wire Closet (RWC)

Area: 70 to 110 Square Feet

Space Description

Scalable space intended to house IT cable racks.

Up to 47 drops: 70 Square Feet 48 to 96 drops: 90 Square Feet 97 to 192 drops: 110 Square Feet

Wall Construction

Walls: S-F Non-Secure Full ht

*See Remarks

Construction

Ceilings: Acoustic Batts above

Floors: NA

Walls: Acoustic Batts

STC Rating: NA

Doors

Door Type/Material: Door Size/Rating: Frame Type/Material: Hardware set:

Fixed Furnishings/Equipment

Casework: NA Specialties: NA Equipment: NA

Mechanical

HVAC: Separate zone HVAC system, 24/7

cooling *See Remarks

Air Pressure: Positive

Plumbing: NA

Communications
Phone/Data Outlets:

Provide combination receptacles per plan

Special Requirements: NA

Remarks

· No windows allowed

 Reference current ICE Cabling Standards and MDF+WC Guidelines No windows allowed

Walls:

 Provide 8'-0" FRT painted plywood on all walls indicated on plan. Install 48" AFF horizontally.

 Leave one FRT manufacturer stamp unpainted on each plywood piece. **Adjacencies**

 Centrally located within ICE space to eliminate need for additional remote wiring closets (RWC) (328' max)

No exterior or demising walls

MDF/RWC should be stacked in multi-story offices n/a

Not adjacent to water sources.

Interior Finishes

Floors: ESD Vinyl flooring (grounded)

Base: 4" Rubber/Vinyl cove

Walls: PTD Gyp Bd Ceiling: ACT

Ceiling Height: 8'-6" Min.

Windows

Interior Frame Material: Interior Frame Size:

Glazing:

Ext. Window Treatment:

Furniture

NΑ

Electrical

Lighting: 80 foot-candles at 60" AFF, controlled

by occupancy sensors.
*Refer to plan for preferred

placement.

Power: Per plan in accordance with

local/state/federal code, whichever is

more stringent *See Remarks

HVAC:


o Wall mounted unit or floor unit optional

 BTU cooling: Refer to ICE Cabling Standards (60-72° F)

Power: Space to be on emergency generator (if applicable)

*Security requirements and layout for design purposes only – final quantity and locations are determined on a project specific basis and in compliance with OPR SOW and approved by the OAFM Project Manager.



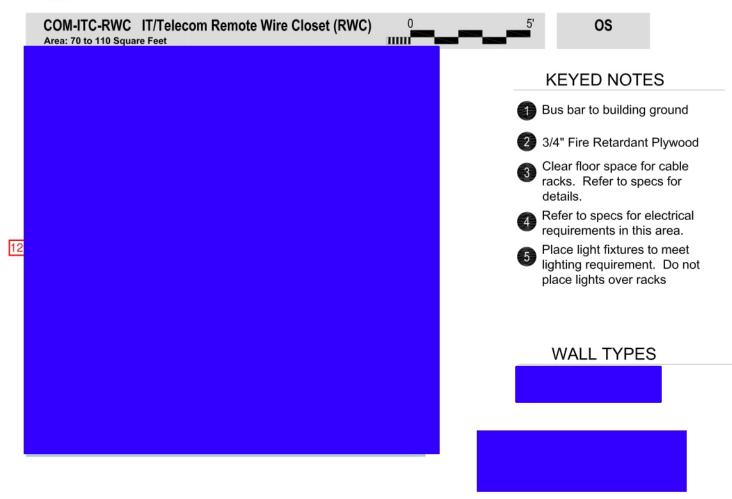

DESIGN CRITERIA

70 Square Feet - up to 48 drops 90 Square Feet - 49 to 96 drops 110 Square Feet - 97 to 192 drops



C/T-12 Conference/Training (9-12)

OS

Space Description

Scalable Conference and/or Training room suited for 9 to 12 people.

Wall Construction

Construction
Ceilings: Acoustic Batts above

Floors: NA

Walls: Acoustic Batts

STC Rating: NA

Doors

Door Type/Material: Door Size/Rating: Frame Type/Material: Hardware set:

Fixed Furnishings/Equipment

Casework: NA

Specialties: White marker board (optional)

Equipment: NA Television provided, please indicate if marker board is required

Mechanical

HVAC: Part of multi-zoned HVAC system

Air Pressure: NA

Plumbing: NA

Communications Phone/Data Outlets:

Provide combination receptacles per plan

*Coordinate final floor location @ table w/ Furniture Vendor. If necessary, mount cable to underside of table top.

Special Requirements:

Review for optional TV cable/satellite and backing for wall mounted display Television provided

Remarks

- Review for Optional components:
 - o VTC
- Operable ceiling mounted projection screen
- A/V capabilities
- Furniture
 - Provide table top A/V box to include data and power.
 - If possible, run A/V cabling under-slab from furniture to TV and A/V equipment

Adjacencies

 Option to be located adjacent to senior management office and include adjoining door.

No adjoining door provided

Interior Finishes

Floors: CPT Tile

Base: 4" Rubber/Vinyl cove

Walls: PTD Gyp Bd Ceiling: ACT

Ceiling Height: 8'-6" Min.

Windows

Part of Glass

Wall System

Interior Frame Material: Interior Frame Size:

Glazing:

Ext. Window Treatment:

Furniture

As indicated on floor plan - *See Remarks
Furniture layout for design purposes only – refer to
furniture vendor for final quantity and design.

Electrical

Lighting: 30-50 foot-candles at 30" AFF,

controlled by occupancy sensors. Dimmable controls / Downlighting / multi-level lighting acceptable.


Power: Per plan in accordance with

local/state/federal code, whichever is

more stringent

*Security requirements and layout for design purposes only – final quantity and locations are determined on a project specific basis and in compliance with OPR SOW and approved by the OAFM Project Manager.



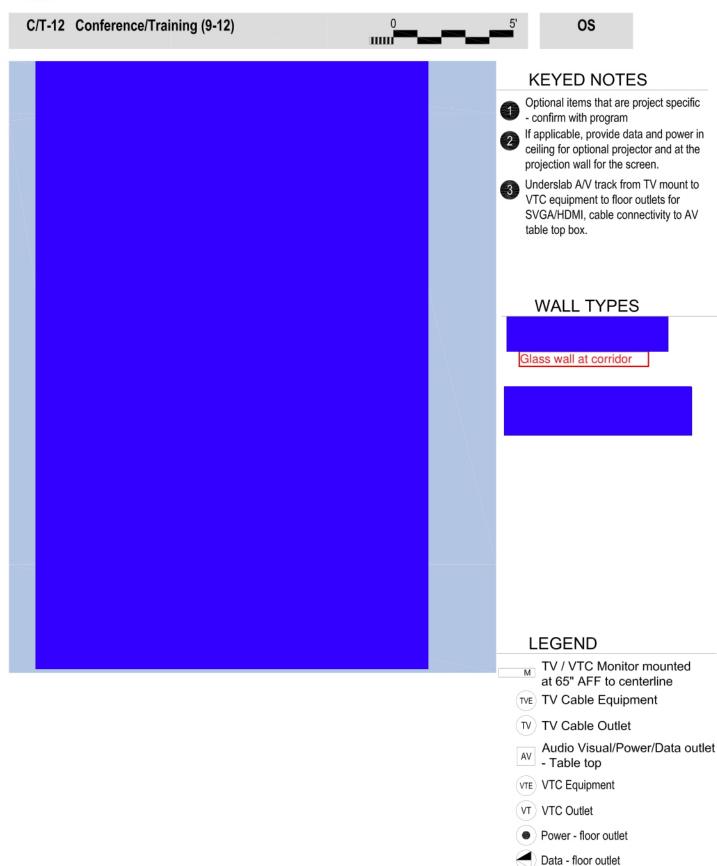



DET-HLD-S Detainee Holding Room, Small (ADA) (1 to 15 Occupants)

MS


Space Description

Space intended to be used for detaining illegal aliens, criminals and/or other apprehended individuals on a temporary basis in a secure confinement area. This space is estimated to house 1-15 people, providing 37 SF for the first occupant and 7 SF for each additional occupant, and is ADA compliant.

Wall Construct	tion	Adjacencies		
Walls:				
Construction		Interior Fini	shes	
Ceilings:		Floors:		
Floors:		Base:		
Walls:		Walls:		
STC Rating:		Coiling H		
Doors		Ceiling Ho Windows		
Door Type/Mat	terial:	Interior Fran	me Material:	
Door Size/Rati		Interior Fran	ne Size:	
Frame Type/Ma	aterial:	Glazing:		
Hardware set:		Ext. Windov	v Treatment:	
Fixed Furnishi	nas/Fauinment	Furniture		
Casework:		NA		
Specialties:				
Equipment: Mechanical		Electrical		
HVAC:	Part of multi-zoned HVAC system	Lighting:	30 foot-candles at 30" AFF, detention	
	(Secured side); Thermostat control in	gg.	grade fluorescent light fixture on	
	staff controlled area		emergency power; prefer recessed;	
	*See Remarks		switch located outside of room	
Air Pressure:	Negative (No mixing w/ building air)	Power:	NA	
Plumbing:				
Communicatio				
Phone/Data Ou				
	e phones (Optional)(Field verify)			
(Field provided) Special Requir				
	conduit must be fully concealed within			
partition or chas				
Domarko				

^{*}Security requirements and layout for design purposes only – final quantity and locations are determined on a project specific basis and in compliance with OPR SOW and approved by the OAFM Project Manager.



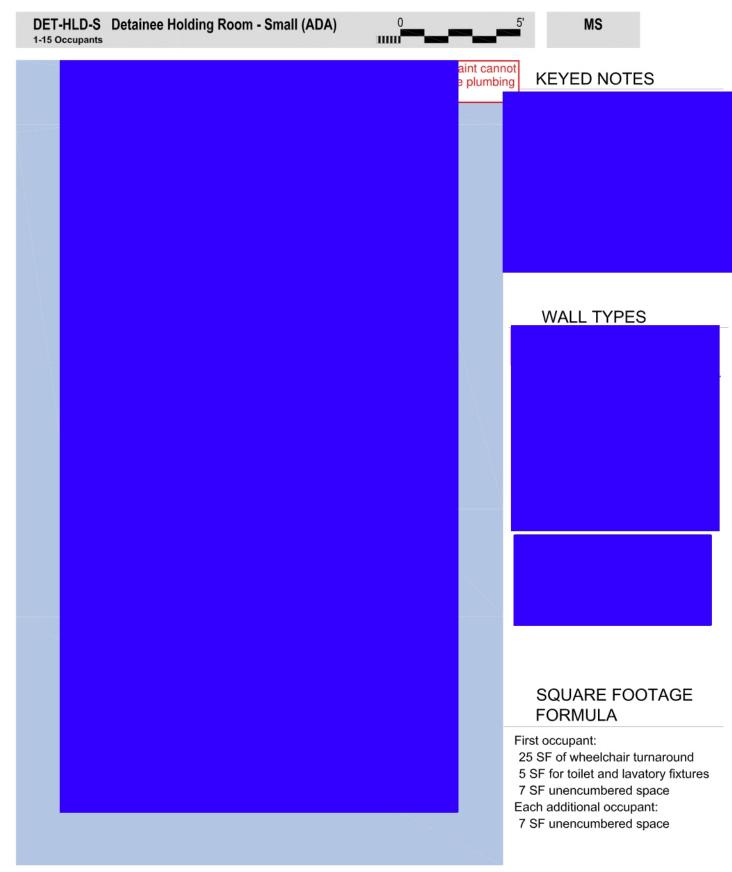




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local/state/federal code, whichever is more stringent more stringent more/Data Outlets:			
more stringent mmunications none/Data Outlets:	Pressure:	Power:	
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	vide combination receptacies per pian		

*Security requirements and layout for design purposes only – final quantity and locations are determined on a project specific basis and in compliance with OPR SOW and approved by the OAFM Project Manager.



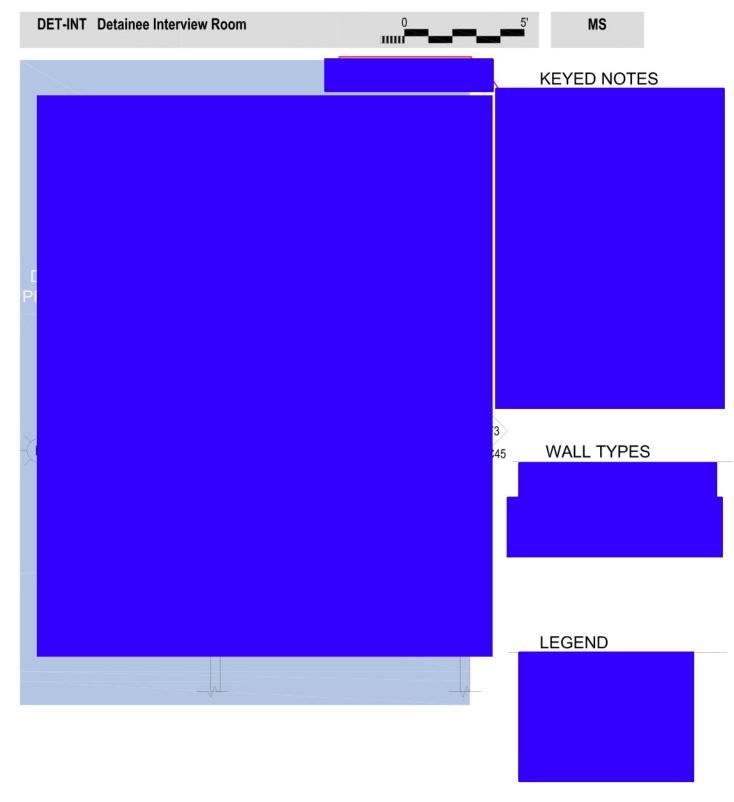



DET-PROC-L Detainee Processing A	Area – Large		MS
Snace Description			
Wall Construction	Adjacen	cies	
Walls:			
Construction	Interior	Finishes	
Ceilings:	Floors:		
Floors: Walls:	Base: Walls:		
STC Rating:	Ceiling:		
	Ceiling I		
Doors Door Type/Material:	Window	S Frame Material:	
Door Size/Rating:		Frame Size:	
Frame Type/Material: Hardware set:	Glazing:	dow Treatment:	
nardware set.	EXt. Win	idow Treatment:	
Fixed Furnishings/Equipment	Furnitur	e	
Casework: NA Specialties: NA	As indica	ated on floor plan	
Equipment: NA			
Mechanical	Electrica	al	
HVAC:	Lighting		30" AFF, detention
		grade fluorescent li	
		emergency power; switch located in st	
Air Pressure:	Power:	Per plan in accorda	ance with
Plumbing:		local/state/federal of more stringent	code, whichever is
		more stringent	
Communications Phone/Data Outlets:			
Provide combination receptacles per plan			
Special Requirements: NA			
Remarks			

^{*}Security requirements and layout for design purposes only – final quantity and locations are determined on a project specific basis and in compliance with OPR SOW and approved by the OAFM Project Manager.



DET-PROC-L Detainee Processing Area - Large



MS

KEYED NOTES

WALL TYPES

LEGEND

5-157




Space constraints only allow for a property closet

DET-PROP-S Detainee Property Room – Small MS Space Description Wall Construction Adjacencies Walls: Interior Finishes Construction Ceilings: Floors: Floors: Base: Walls: Walls: STC Rating: Ceiling: Ceiling H Doors Windows Door Type/Material: Interior Frame Material: Door Size/Rating: Interior Frame Size: Frame Type/Material: Glazing: **Ext. Window Treatment:** Hardware set: Fixed Furnishings/Equipment Furniture Casework: As indicated on floor plan Specialties: **Equipment:** Mechanical Electrical HVAC: Lighting: 30 foot-candles at 30" AFF, detention grade fluorescent light fixture on emergency power; prefer recessed Air Pressure: Per plan in accordance with Power: local/state/federal code, whichever is Plumbing: more stringent Communications Phone/Data Outlets: Provide combination receptacles per plan Special Requirements: Remarks

*Security requirements and layout for design purposes only – final quantity and locations are determined on a project specific basis and in compliance with OPR SOW and approved by the OAFM Project Manager.




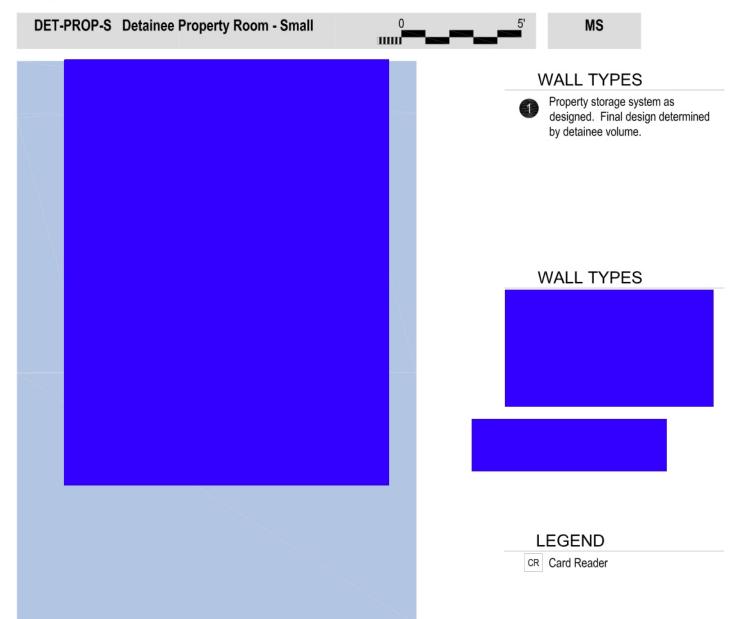



DET-SP-S Detainee Sallyport – Small	MS
Space Description	
Wall Construction Walls:	Adiacencies
wans:	
Construction	Interior Finishes
Ceilings: Floors:	Floors: Base:
Walls:	Walls:
STC Rating:	Ceiling:
	Ceiling H
Doors	Windows
Door Type/Material: Door Size/Rating:	Interior Frame Material: Interior Frame Size:
Frame Type/Material:	Glazing:
Hardware set:	Ext. Window Treatment:
Fixed Furnishings/Equipment	Furniture
Casework:	NA
Specialties:	
Equipment:	
Mechanical	Electrical
HVAC:	Lighting:
Air Pressure:	Power:
All Flessule.	rower.
Plumbing:	
Communications	
Phone/Data Outlets:	
Provide combination receptacles per plan	
Special Requirements: NA	
Remarks	
*Socurity requirements and layout for decise pur	rposes only – final quantity and locations are determined



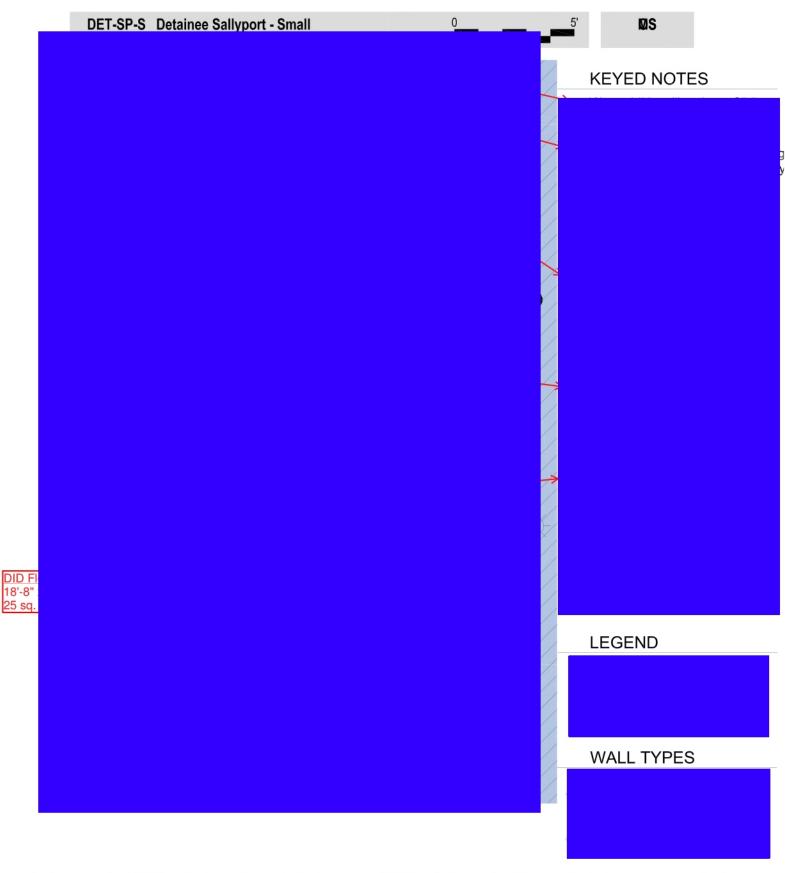




Labeled Mantrap on Floor Plans

Ceilings: Cloors: Walls: Correct Rating: Door Spoor Type/Material: Door Size/Rating: Floors: Hardware set: Fixed Furnishings/Equipment Casework: Specialties: Equipment: Mchanical HVAC: Part of multi-zoned HVAC system (Secured side); Thermostat control in staff controlled area Air Pressure: NA Plumbing: NA Communications Phone/Data Outlets: Provide combination receptacles per plan Special Requirements: NA Floors: Base: Walls: Ceiling: Walls: Ceiling H Windows Interior Frame Material: Interior Frame Material: Interior Frame Material: Interior Frame Size: Glazing: Ext. Window Treatment: Furniture As indicated on floor plan (Optional) Floors: Base: Walls: Ceiling: Celling: Valis: Ceiling: Ext. Windows Interior Frame Material: Interior Frame Valua Interior Frame	52. 120 0	S Detainee Vestibule/Search – Small		MS
Interior Finishes Floors: Floors: Walls: Floors: Walls: Ceiling:	pace Descrip	tion		
Ceilings: Cloors: Walls: Correct Rating: Door Spoor Type/Material: Door Size/Rating: Flors: Base: Walls: Ceiling H Windows Interior Frame Material: Interior Frame Size: Glazing: Ext. Window Treatment: Furniture Casework: Specialties: Equipment: Mechanical HVAC: Part of multi-zoned HVAC system (Secured side); Thermostat control in staff controlled area Air Pressure: NA Plumbing: NA Communications Phone/Data Outlets: Provide combination receptacles per plan Special Requirements: NA Floor: Base: Walls: Ceiling: Ceiling H Windows Interior Frame Material: Interior Frame Size: Glazing: Ext. Window Treatment: Furniture As indicated on floor plan (Optional) Power: Per plan in accordance with Iocal/state/federal code, whichever is more stringent Special Requirements: NA Special Requirements: NA		tion	Adjacencies	
Door Spe/Material: Door Type/Material: Door Size/Rating: Frame Type/Material: Hardware set: Eixed Furnishings/Equipment Casework: Specialties: Equipment: Mechanical HVAC: Part of multi-zoned HVAC system (Secured side); Thermostat control in staff controlled area Air Pressure: NA Plumbing: NA Communications Phone/Data Outlets: Provide combination receptacles per plan Windows Interior Frame Material: Interior Frame Size: Glazing: Ext. Window Treatment: Furniture As indicated on floor plan (Optional) Electrical Lighting: 30 foot-candles at 30" AFF, detention grade fluorescent light fixture on emergency power; prefer recessed; switch located outside of room Power: Power: Power: Power: Provide combination receptacles per plan Special Requirements: NA	Construction Ceilings: Floors: Walls: STC Rating:		Floors: Base: Walls: Ceiling:	shes
As indicated on floor plan (Optional)	Door Size/Rati	ng:	Windows Interior Fran Interior Fran Glazing:	ne Size:
HVAC: Part of multi-zoned HVAC system (Secured side); Thermostat control in staff controlled area Air Pressure: NA Plumbing: NA Communications Phone/Data Outlets: Provide combination receptacles per plan Lighting: 30 foot-candles at 30" AFF, detention grade fluorescent light fixture on emergency power; prefer recessed; switch located outside of room Per plan in accordance with local/state/federal code, whichever is more stringent Special Requirements: NA Special Requirements: NA	Fixed Furnishi Casework: Specialties: Equipment:	ngs/Equipment		on floor plan (Optional)
Air Pressure: NA Plumbing: NA Communications Phone/Data Outlets: Provide combination receptacles per plan Special Requirements: NA		(Secured side); Thermostat control in		grade fluorescent light fixture on emergency power; prefer recessed;
Communications Phone/Data Outlets: Provide combination receptacles per plan Special Requirements: NA	Air Pressure:		Power:	Per plan in accordance with local/state/federal code, whichever is
	Communication Phone/Data Ou	ons utlets:		
Remarks	Special Requir	rements: NA		
	Remarks			

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FIT-L/S Locker/Showers

OS / MS

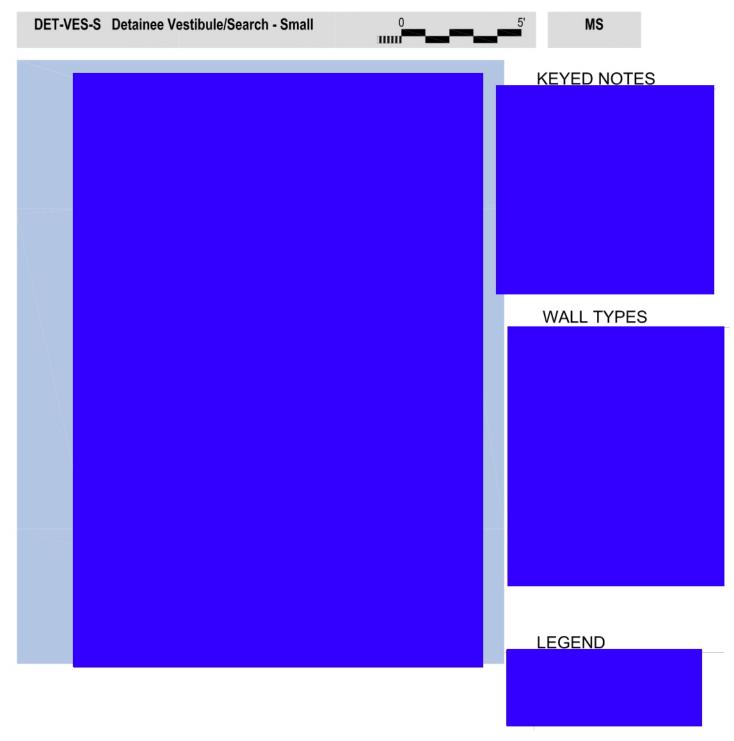Space Description

Wall Construction

Walls:

Adjacencies

Interior Finishes

Ceiling Height:

Interior Frame Material:

Ext. Window Treatment:

As indicated on floor plan

Interior Frame Size:

Floors:

Base:

Walls:

Ceiling:

Windows

Glazing:

Furniture

FIT-FR-S or FIT-FR-L Fitness Room (If applicable)

FIT-MR Mat Room (If applicable)

PTD Gyp Bd

9'-0" Min.

Furniture layout for design purposes only - refer to

furniture vendor for final quantity and design.

Construction

Ceilings: Acoustic Batts above

Floors: NA

Walls: Acoustic Batts

STC Rating: NA

Doors

Door Type/Material: A / SCWD Door Size/Rating: 3'-0" x 7'-0" / NA

Frame Type/Material: 1 / HM or 2 / Masonry HM 06

Hardware set:

Locker Room

10 Lockers Men

4 Lockers Women

Space Constraints do

not Allow of Bench

Fixed Furnishings/Equipment

Casework: Lavatory counter *See Remarks 🗸 Specialties:

Equipment: Full height lockers w/ integral or

pedestal bench

Mechanical

HVAC: Part of multi-zoned HVAC system

Lockers and benches provided by GC. Electrical

Lighting:

50 foot-candles at 30" AFF, controlled

Quarry Tile (QT) Large Format Porcelain Tile

Quarry Tile (QT) Large Format Porcelain Tile

Ceramic tile (Min. 6' high); PTD Gyp Bd

NA

NA

NA

NA

by occupancy sensors. Vandal resistant grade, damp/wet rated

fixtures.

Per plan in accordance with Power:

local/state/federal code, whichever is

more stringent

Air Pressure: Negative

Plumbing: *See Remarks

Communications

Phone/Data Outlets: NA


Special Requirements: NA

Remarks

- · Rooms shall be designed such that there is no line of sight into person using locker or plumbing fixture.
- S-F (Typ.) and/or M-C should be used at perimeter
- S-P and/or M-C-P2 can be used for interior walls
- Mechanical/Plumbing
 - Include floor drains, showers, lavatories, urinals, water closets and water fountains per code.
 - o Wall hung toilet fixtures preferred.

- Fixed Furnishings/Specialties:
 - Ceiling mounted toilet partitions metal or solid surface
 - 4' high frameless shatterproof glass mirror for full length of lavatory counter
 - Shower rods, shower curtains or shower doors
 - o Soap and paper towel dispensers
 - Toilet paper holders
 - o Towel pins and grab bars
 - Waste receptacles



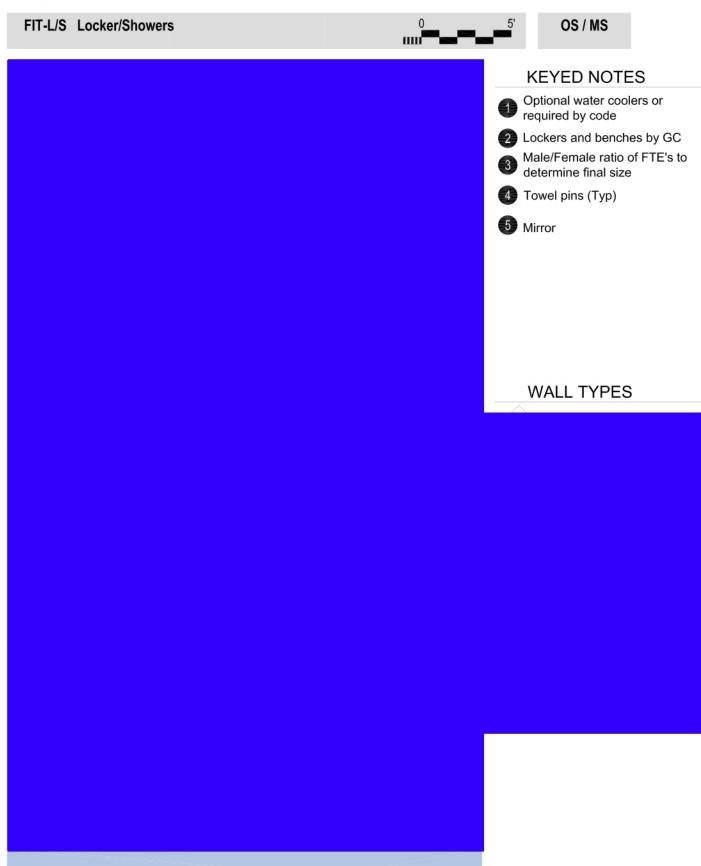



FIT-MR Mat Room

MS

Space Description

Scalable space intended for exercising/training and to be used in conjunction with the Locker/Showers. This space available for offices with employees with Law Enforcement requirements.

Wall Construction

Walls: S-F Non-Secure Full ht

*See Remarks

Construction

Ceilings: Acoustic Batts above

Floors: NA

Walls: Acoustic Batts

STC Rating: NA

Doors

Door Type/Material: A / SCWD

Door Size/Rating: 3'-0" (or 3'-6") x 7'-0" / NA

Frame Type/Material: 1 / HM

Hardware set: E6 or 05 / F05

Electronic or Fitness Room

Fixed Furnishings/Equipment

Casework: NA

Specialties: *See Interior Finishes/Walls

Equipment: NA

Mechanical

HVAC: Dependent on size and design, a

single zone HVAC may be used, otherwise space should be part of

multi-zoned HVAC system

Air Pressure: Negative

Plumbing: Water fountains as required by code

Communications

Phone/Data Outlets:

If requested, provide optional phone outlet per plan

Special Requirements: NA

Remarks

 In locations with multiple ICE offices, the Mat Room and conjunction spaces will be shared space.

Walls:

 Provide 8'-0" 3/4" plywood on all walls that will receive wall pads.

Interior Finishes/Floors:

 Interlocking rubber tile mats or roll rubber mats hot welded Adjacencies

• FIT-L/S Locker/Showers

Preferred location away from occupied space

Located as Remote as possible from office areas

Interior Finishes

Floors: *See Remarks
Base: 4" Rubber/Vinyl cove

Walls: PTD Gyp Bd; 6' high wall pads *See Remarks/Walls

Ceiling: ACT

Ceiling Height: 9'-0" Min.

Windows

Interior Frame Material: NA
Interior Frame Size: NA
Glazing: NA
Ext. Window Treatment: Blinds

*Blast film if reqd

Furniture

As indicated on floor plan

Furniture layout for design purposes only – refer to furniture vendor for final quantity and design.

Electrical


Lighting: 30 foot-candles at 30" AFF

Power: Per plan in accordance with

local/state/federal code, whichever is

more stringent



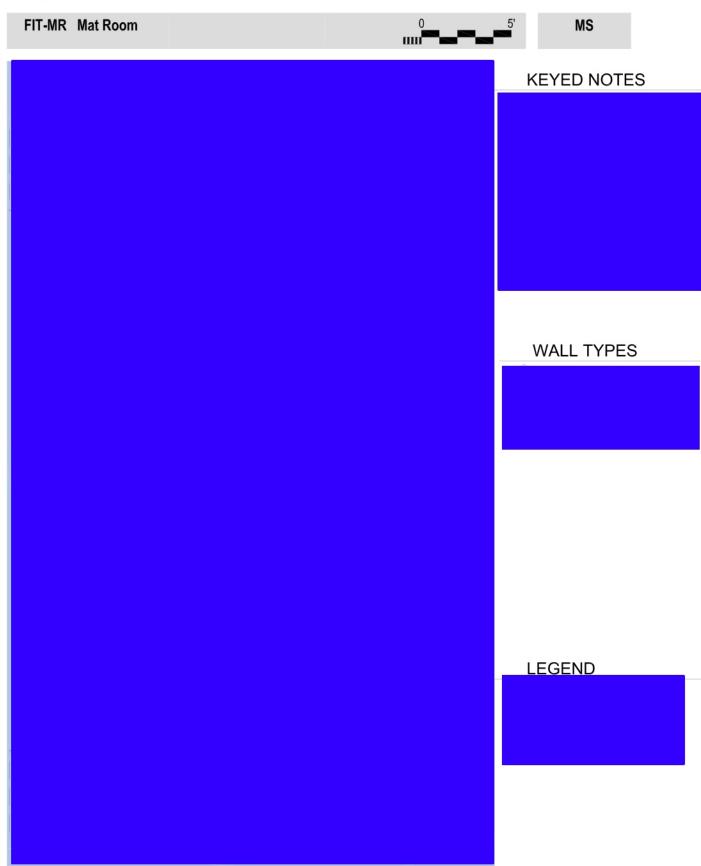



OFF-PVT-100 Office

Area: 100 Square Feet

os

Space Description

Hard-walled space where one person works as dictated by the ICE Office and Workstation Standards. This may include casegoods and/or free-standing furniture.

Wall Construction

Walls:

Adjacencies

OSP-W Waiting Area (if required)

C/T-XX Conference/Training (optional)

Construction

Ceilings: Acoustic Batts above

Floors: NA

Walls: Acoustic Batts

STC Rating: NA

Doors

Door Type/Material: Door Size/Rating: Frame Type/Material: Hardware set:

Fixed Furnishings/Equipment

Casework: NA Specialties: NA Equipment: NA

Mechanical

HVAC: Part of multi-zoned HVAC system

Air Pressure: NA

Plumbing: NA

Communications
Phone/Data Outlets:

Provide combination receptacles per plan

Special Requirements:

Review for optional TV cable/satellite and backing for wall mounted display

Remarks

 If the final layout incorporates "in-board" offices (not on an exterior wall), those offices can utilize the option of a door with a sidelight or include a window to obtain natural light. Interior Finishes

Floors: CPT Tile
Base: 4" Rubber/Vinyl cove

Walls: PTD Gyp Bd

Ceiling: ACT (2 X 2 preferred) **Ceiling Height:** 8'-6" Min.

Windows

Interior Frame Material: Interior Frame Size:

Glazing:

Ext. Window Treatment:

Furniture

As indicated on floor plan

Furniture layout for design purposes only – refer to furniture vendor for final quantity and design.

Electrical

Lighting: 30-50 foot-candles at 30" AFF,

controlled by occupancy sensors.


Power: Per plan in accordance with

local/state/federal code, whichever is


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5-15



OFF-PVT-120 Office

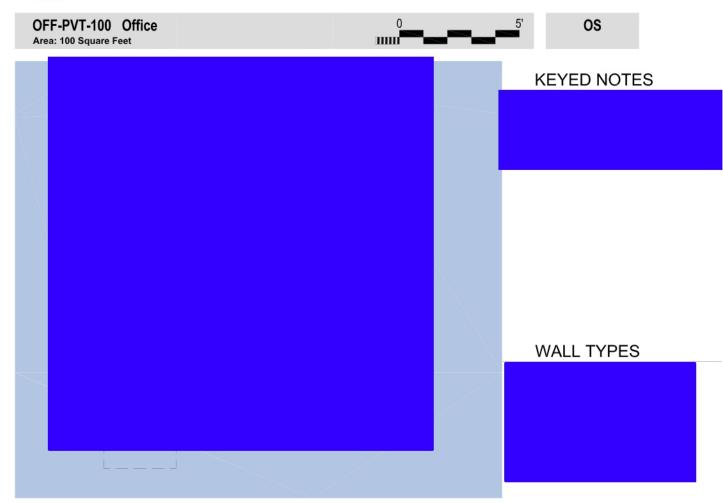Area: 120 Square Feet

os

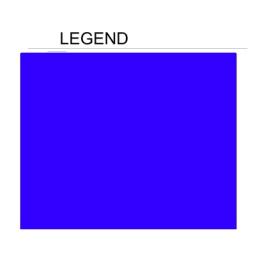Space Description

Hard-walled space where one person works as dictated by the ICE Office and Workstation Standards. This may include casegoods and/or free-standing furniture.

Wall Construction

Walls:

Adjacencies

- OSP-W Waiting Area (if required)
- C/T-XX Conference/Training (optional)

Construction

Ceilings: Acoustic Batts above

Floors: NA

Walls: Acoustic Batts

STC Rating: NA

Doors

Door Type/Material: Door Size/Rating: Frame Type/Material: Hardware set:

Fixed Furnishings/Equipment

Casework: NA Specialties: NA **Equipment:** NA

Mechanical

HVAC: Part of multi-zoned HVAC system

Air Pressure: NA

Plumbing:

NΑ

Communications Phone/Data Outlets:

Provide combination receptacles per plan

Special Requirements:

Review for optional TV cable/satellite and backing for

wall mounted display

Remarks

• If the final layout incorporates "in-board" offices (not on an exterior wall), those offices can utilize the option of a door with a sidelight or include a window to obtain natural light.

Interior Finishes Floors:

CPT Tile 4" Rubber/Vinyl cove Base:

Walls: PTD Gyp Bd

Ceiling: ACT (2 X 2 preferred) Ceiling Height: 8'-6" Min.

Windows

Interior Frame Material: Interior Frame Size:

Glazing:

Ext. Window Treatment:

Furniture

As indicated on floor plan

Furniture layout for design purposes only - refer to furniture vendor for final quantity and design.

Electrical

Lighting: 30-50 foot-candles at 30" AFF,

controlled by occupancy sensors.

Per plan in accordance with Power:

local/state/federal code, whichever is


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^{*}Security requirements and layout for design purposes only - final quantity and locations are determined on a project specific basis and in compliance with OPR SOW and approved by the OAFM Project Manager.









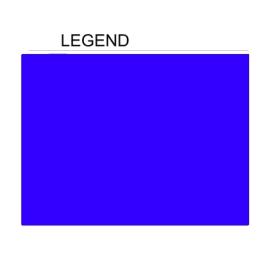

OSP-BR-08 Break Room (1-8)

os

Space Description

Scalable space for 1 to 8 ICE employees to prepare and eat meals. Area should include space for vending machines (if applicable) and can include millwork (base and upper cabinets).

Wall Construction

Walls: S-P Slab to above ceiling partition

Adjacencies

Construction

Ceilings: Acoustic Batts above

Floors: NA

Walls: Acoustic Batts

STC Rating: NA

Doors

no vendina

machines

Door Type/Material: Door Size/Rating: Frame Type/Material:

Hardware set:

Fixed Furnishings/Equipment

Casework: *See Remarks

Specialties: Vending Machines coordinate elec.

Equipment: Double basin SS sink

Mechanical

HVAC: Part of multi-zoned HVAC system

Air Pressure: NA

Plumbing: H/C water & drain for sink

Water line for refrigerator (Optional)

Communications

Phone/Data Outlets:

Provide combination receptacles per plan

Special Requirements:

TV to be provided

Review for optional TV cable/satellite and backing for wall mounted display.

Remarks

- All appliances per program office coordinate size and electrical requirements (refrigerator, coffee maker and microwave, etc.)
- · Design criteria: 25% of total FTE
- Vending machines only applicable if not available elsewhere in building.

No Vending Machines

Interior Finishes

Floors: Vinyl Composition Tile (VCT) Wood Look LVT Plank

Base: 4" Rubber/Vinyl cove

Walls: PTD Gyp Bd Ceiling: ACT

Ceiling Height: 8'-6" Min.

Windows

Interior Frame Material: Interior Frame Size:

Glazing:

Ext. Window Treatment:

Furniture

As indicated on floor plan.

Furniture layout for design purposes only – refer to furniture vendor for final quantity and design.

Electrical

Lighting: 15-30 foot-candles at 30" AFF,

controlled by occupancy sensors.


Power: Per plan in accordance with

local/state/federal code, whichever is

more stringent

- Door Type:
 - o A / SCWD or C / Flush WD w/ vision panel
- Casework: Plywood Cabinets
 - Plastic laminate cabinet (base & upper) with solid surface or plastic laminate countertop



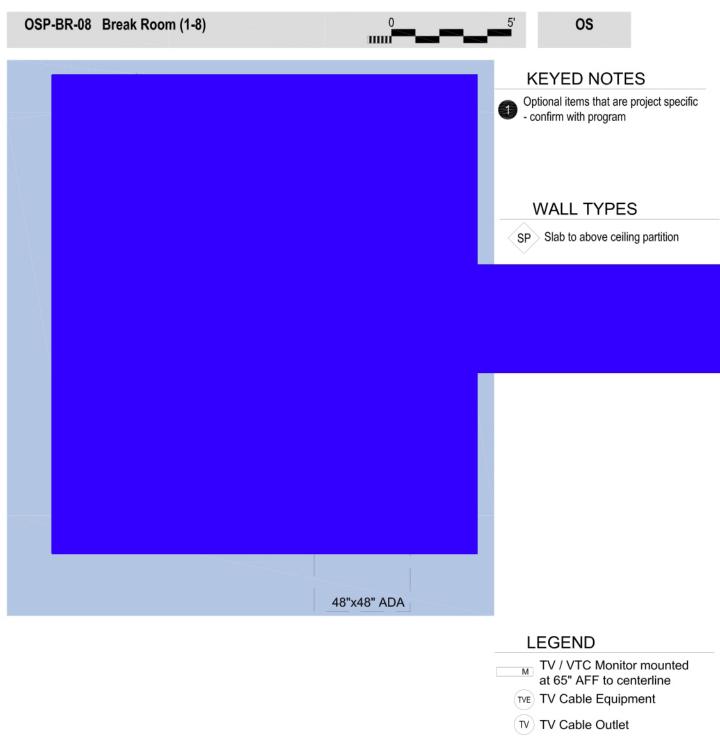



OSP-AF File Room, Alien

MS

Space Description

Scalable space intended for storage of alien files.

Wall Construction

Walls: S-P Slab to above ceiling partition

Adjacencies

- Admin areas (recommended)
- Trial Prep areas (OPLA)

Construction

Ceilings: NA Floors: NA Walls: NA STC Rating: NA

Doors

Door Type/Material: Door Size/Rating: Frame Type/Material: Hardware set:

Fixed Furnishings/Equipment

Casework: NA Specialties: NA

Equipment: High-Density file system (if applicable)

*(See Remarks)

Mechanical

HVAC: Part of multi-zoned HVAC system

Air Pressure: NA

Plumbing: NA

Communications

Phone/Data Outlets:

Provide combination receptacles per plan

Special Requirements: NA

Interior Finishes

Floors: CPT Tile or Vinyl Composition Tile (VCT)

Base: 4" Rubber/Vinyl cove Walls: PTD Gyp Bd

Ceiling: ACT

Ceiling Height: 8'-6" Min.

Windows

Interior Frame Material: NA
Interior Frame Size: NA
Glazing: NA
Ext. Window Treatment: NA

Furniture

As indicated on floor plan* (See Remarks)
Furniture layout for design purposes only – refer to furniture vendor for final quantity and design.

Electrical

Lighting: 30-50 foot-candles at 30" AFF,

controlled by occupancy sensors.

Power: Per plan in accordance with


local/state/federal code, whichever is

more stringent

Remarks

- Scalable file system dependent on file volume (coordinate with furniture vendor)
- Equipment/Furniture: Lockable file cabinets or optional High-Density file system w/ lockable file storage.
- Consider floor loading/limitations if using highdensity filing system for floors 2+.




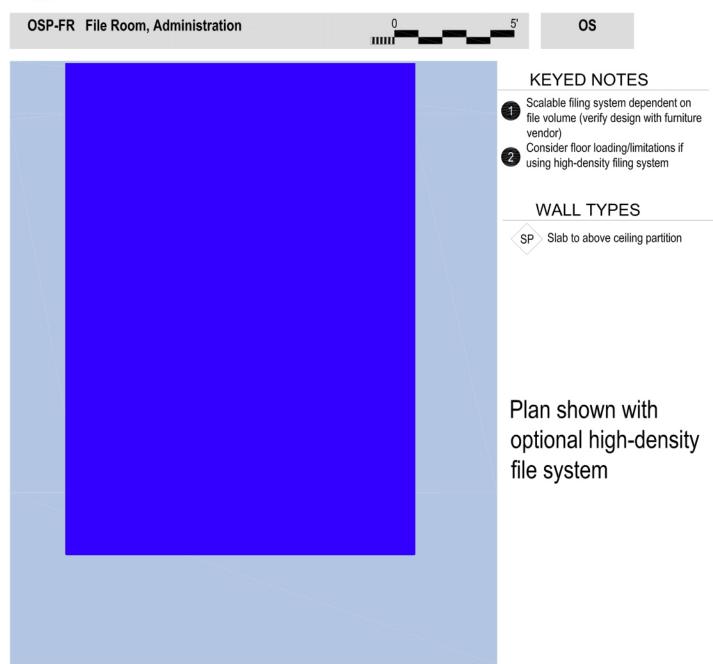



OSP-I/I Interview Room MS Space Description Wall Construction Adjacencies Walls: Public areas (if applicable) OSP-REC-X Secure Reception/Waiting (if applicable) DET-OBSV Detainee Observation Room (if applicable) Construction Interior Finishes CPT Tile or Vinyl Composition Tile (VCT) Acoustic Batts above Ceilings: Floors: Floors: NA Base: 4" Rubber/Vinyl cove Walls: Acoustic Batts Walls: PTD Gyp Bd STC Rating: 45 Ceiling: ACT Ceiling Height: 8'-6" Min. Doors Windows Door Type/Material: Interior Frame Material: HM No Interior Door Size/Rating: Interior Frame Size: 36" X 48" Windows Frame Type/Material: Glazing: One-way, Type 5 **Ext. Window Treatment:** Hardware set: Not allowed Fixed Furnishings/Equipment Furniture Casework: NA As indicated on floor plan. Is this Required? Specialties: NA Furniture layout for design purposes only - refer to Optional handcuff bar **Equipment:** furniture vendor for final quantity and design. Optional bolt down stool/bench w/ handcuff rings Mechanical Electrical HVAC: Part of multi-zoned HVAC system Lighting: 30-50 foot-candles at 30" AFF. Thermostat to be located on secure Switch to be located outside of space side on secure side *See Remarks for In-Use light Per plan in accordance with Air Pressure: NA Power: local/state/federal code, whichever is Plumbing: NA more stringent Communications Phone/Data Outlets: Provide combination receptacles per plan Special Requirements: Remarks



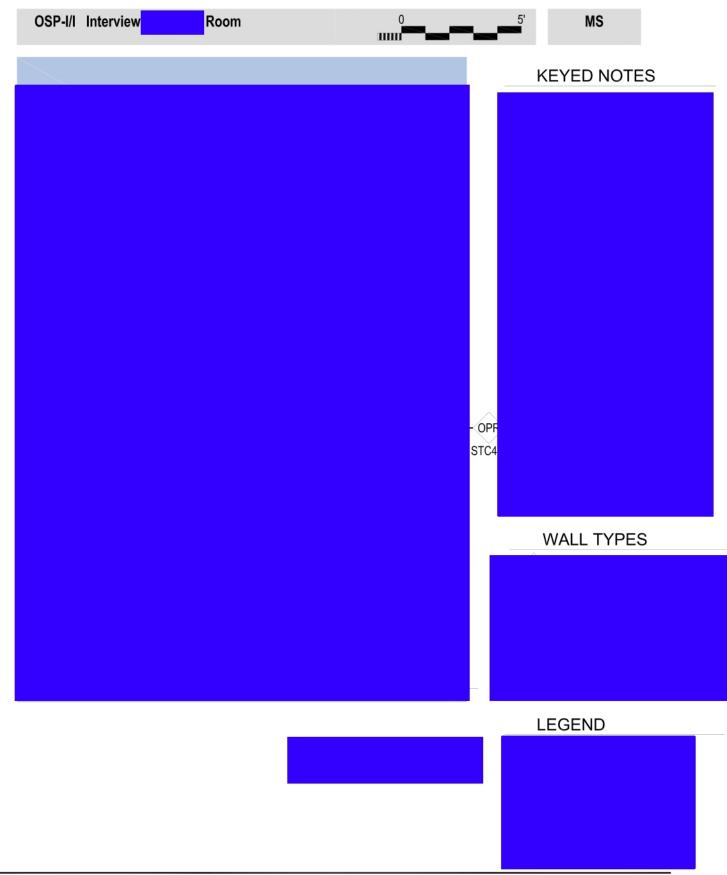



OSP-REC-L Secure Reception/Waiting Large

OS

Porcelain Tile and Walk-Off

Mat at Vestibules

Space Description

Dedicated scalable space for receiving visitors and controlling access to the tenant spaces for both staff and visitors.

Wall Construction

Walls:

Adjacencies

- OSP-I/I Interview/Informant Room (If applicable)
- WS-S-XX Reception workstation @ transaction window
- DET-VIS-RM Non-Contact Visitation (If applicable)
- Public Restrooms (If applicable)

Construction

Ceilings: Acoustic Batts above

Floors: NA

Walls: Acoustic Batts

STC Rating: NA

Doors

Door Type/Material: Door Size/Rating: Frame Type/Material: Hardware set:

Fixed Furnishings/Equipment

Casework: NA Specialties: NA Equipment: NA

Mechanical

HVAC: Part of multi-zoned HVAC system

Air Pressure: NA

Plumbing: Plumbing fixtures per code if public

toilet is designed

Communications

Phone/Data Outlets:

Provide combination receptacles per plan

Special Requirements:

Review for optional TV cable/satellite and backing for wall mounted display No Television Provided

Remarks

Interior Finishes

Floors: CPT Tile, Quarry Tile or Vipyl Composition Tile

Base: 4" Rubber/Vinyl cove

Walls: PTD Gyp Bd

Ceiling: ACT

Ceiling Height: 8'-6" Min.

Windows

Interior Frame Material:

Interior Frame Size:

Glazing:

Ext. Window Treatment:

Furniture

As indicated on floor plan

Furniture layout for design purposes only – refer to furniture vendor for final quantity and design.

Electrical


Lighting: 30-50 foot-candles at 30" AFF

Power: Per plan in accordance with

local/state/federal code, whichever is

more stringent



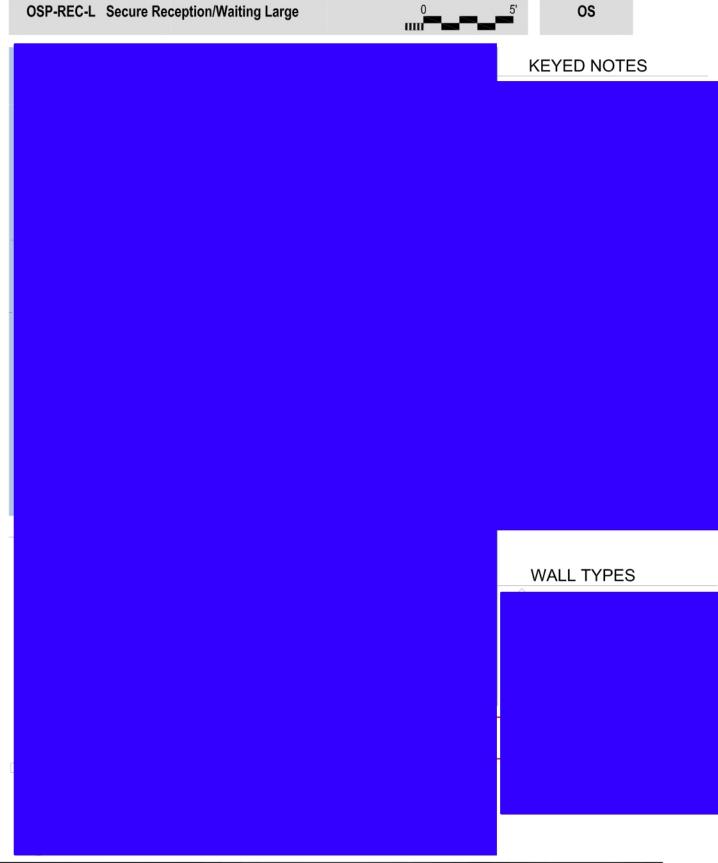



OSP-SC Office Support Center

OS

Space Description

Scalable space utilized in administration spaces to accommodate network printers, copiers, fax machines and office supplies. This can include millwork (base and upper cabinets) or free standing furniture.

Wall Construction

Walls: NA (Intent is to utilize open space and

adjoining walls)

Adjacencies

Admin areas

Construction

Ceilings: Per adjacent construction
Floors: Per adjacent construction
Walls: Per adjacent construction

STC Rating: NA

Doors

Door Type/Material: NA
Door Size/Rating: NA
Frame Type/Material: NA
Hardware set: NA

Fixed Furnishings/Equipment

Casework: As designed Specialties: NA Equipment: NA

work surface at Support window

Mechanical

HVAC: Part of multi-zoned HVAC system

Air Pressure: NA

Plumbing: NA

Interior Finishes

Floors: CPT Tile or Vinyl Composition Tile (VCT)

Base: 4" Rubber/Vinyl cove Walls: PTD Gyp Bd

Ceiling: ACT

Ceiling Height: 8'-6" Min.

Windows

Interior Frame Material: NA
Interior Frame Size: NA
Glazing: NA
Ext. Window Treatment: NA

Furniture

Base cabinets, countertop, upper cabinets with option to use file cabinets and storage units as work surfaces. Layout for design purposes only.

Electrical

Lighting: 30-50 foot-candles at 30" AFF,

controlled by occupancy sensors.

Power: Per plan in accordance with

local/state/federal code, whichever is

more stringent

Communications

Phone/Data Outlets:

Provide combination receptacles per plan

Special Requirements: NA

Verify if large format plotter requirements apply

Remarks

 Office Support Centers (OSC) should be dispersed throughout ICE ADMIN space in lieu of one central location if project dictates multiple OSC's.


· Utilize adjacent walls and open space for OSC.

 Bottom of upper cabinets should be at 24"+ abovelower cabinet countertop to allow for printers/fax machines.

· Confirm power requirements for copier.

No Cabinets



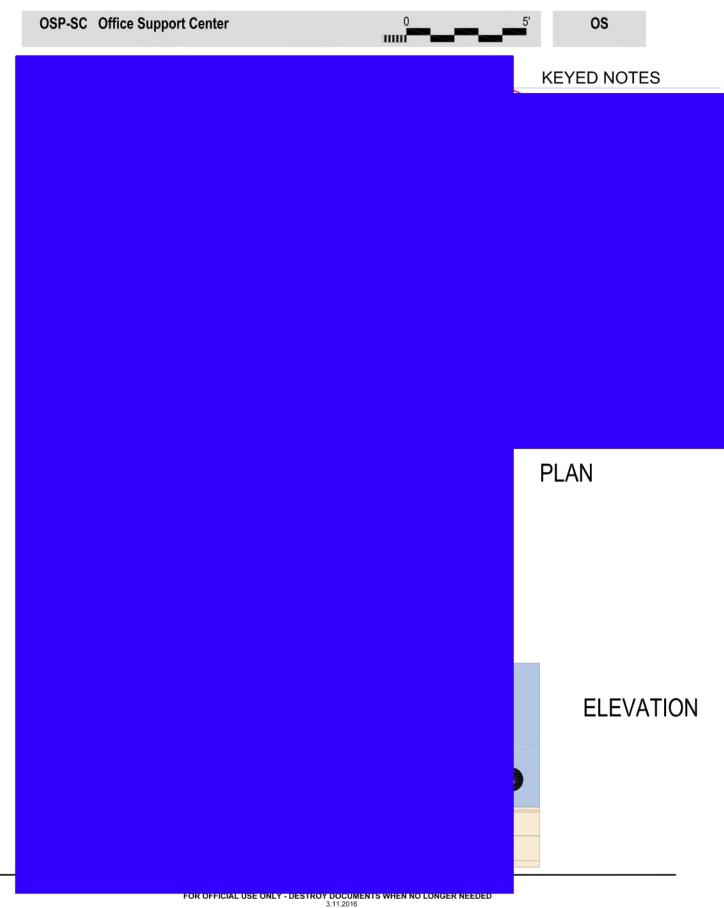



OSP-SR Supply Room

os

Space Description

Scalable space required for storage and distribution of supplies used in the daily operation of the office. This may include free standing furniture.

Wall Construction

Walls: S-P Slab to above ceiling partition

Adjacencies

· Admin areas

Construction

Ceilings: NA Floors: NA Walls: NA STC Rating: NA

Doors

Door Type/Material: Door Size/Rating: Frame Type/Material: Hardware set:

Fixed Furnishings/Equipment

Casework: NA Specialties: NA Equipment: NA

Mechanical

HVAC: Part of multi-zoned HVAC system

Air Pressure: NA

Plumbing: NA

Communications
Phone/Data Outlets:

Special Requirements:

Interior Finishes

Floors: Vinyl Composition Tile (VCT) CPT-T

Base: 4" Rubber/Vinyl cove

Walls: PTD Gyp Bd Ceiling: ACT

Ceiling Height: 8'-6" Min.

Windows

Interior Frame Material: NA
Interior Frame Size: NA
Glazing: NA
Ext. Window Treatment: NA

Furniture

As indicated on floor plan.

Furniture layout for design purposes only – refer to furniture vendor for final quantity and design.

Electrical

Lighting: 30-50 foot-candles at 30" AFF,

controlled by occupancy sensors.

Power: Per plan in accordance with

local/state/federal code, whichever is

more stringent

Security *

CCTV: NA
Access Control: NA
Duress System: NA
IDS: NA

Remarks


 Utilize bookcases, storage cabinets, lateral files and open shelving products.

NA

NΑ

No exterior windows




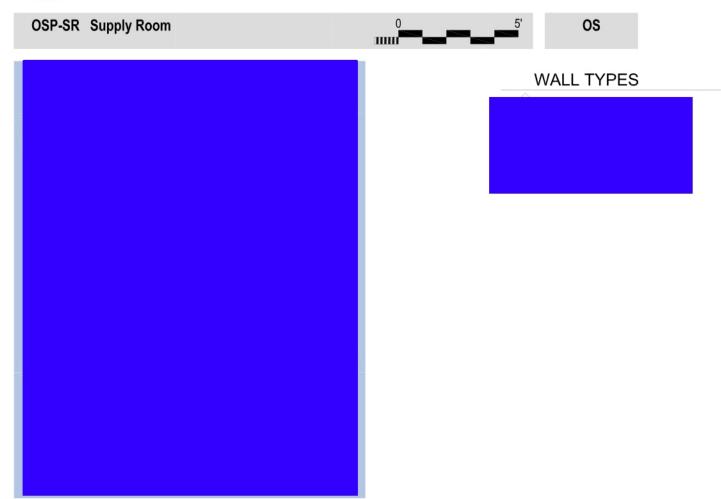



SEC-AWST MS Space Description Wall Construction Adiacencies Walls: Construction Interior Finishes CONC - sealed Floors: Ceilings: Floors: Base: 4" Rubber/Vinyl cove Walls: Walls: PTD Gyp Bd STC Rating: Ceiling: *See Remarks Ceiling Height: *See Remarks Doors Windows Door Type/Material: **Interior Frame Material:** NA Door Size/Rating: Interior Frame Size: NA Frame Type/Material: Glazing: NA **Ext. Window Treatment:** Hardware set: NA Fixed Furnishings/Equipment Furniture Casework: NA As indicated on floor plan *See Remarks Specialties: Furniture layout for design purposes only - refer to **Equipment:** furniture vendor for final quantity and design. NA Electrical Mechanical Part of multi-zoned HVAC system Lighting: 30 foot-candles at 30" AFF, controlled HVAC: *See Remarks by occupancy sensors. Air Pressure: NA Power: Per plan in accordance with local/state/federal code, whichever is Plumbing: NA more stringent Communications Phone/Data Outlets: NA Special Requirements: NA Remarks



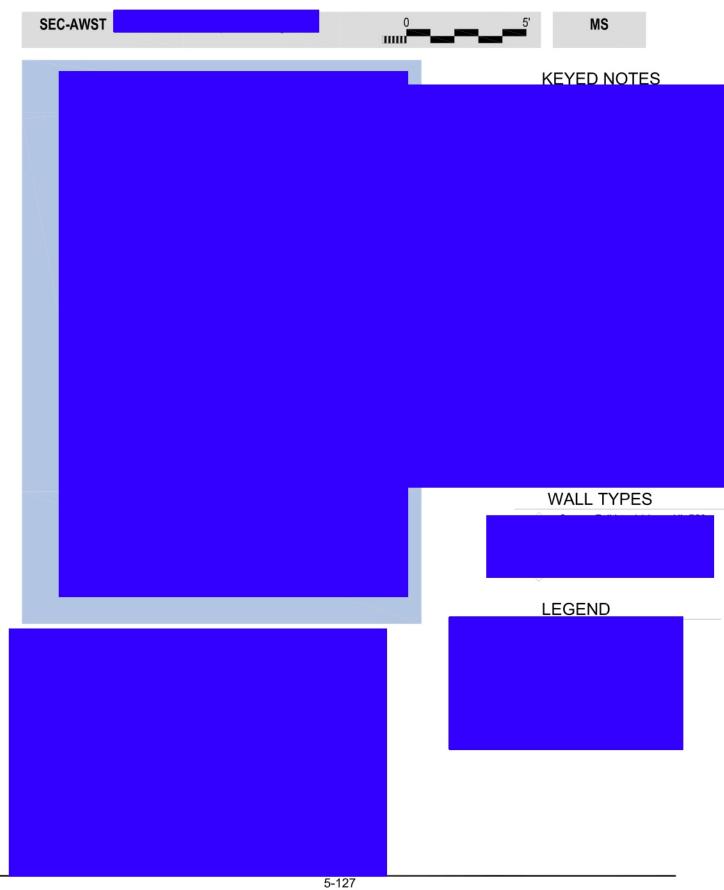



Space Description MS

Wall Construction

Walls:

Adjacencies

Construction

Ceilings: NA Floors: NA Walls: NA STC Rating: NA

Doors

Door Type/Material: Door Size/Rating: Frame Type/Material: Hardware set:

Fixed Furnishings/Equipment

Casework: NA Specialties: NA Equipment: NA

Mechanical

HVAC: Part of multi-zoned HVAC system

NA

NA

Air Pressure: NA

Plumbing: NA

Communications
Phone/Data Outlets:

Special Requirements:

Remarks

Interior Finishes

Floors: Vinyl Composition Tile (VCT)

Base: 4" Rubber/Vinyl cove

Walls: PTD Gyp Bd Ceiling: ACT

Ceiling Height: 8'-6" Min.

Windows

Interior Frame Material: NA
Interior Frame Size: NA
Glazing: NA
Ext. Window Treatment: NA

Furniture

As indicated on floor plan

Furniture layout for design purposes only – refer to furniture vendor for final quantity and design.

Electrical

Lighting: 30-50 foot-candles at 30" AFF,

controlled by occupancy sensors.

Power: Per plan in accordance with

local/state/federal code, whichever is

more stringent

^{*}Security requirements and layout for design purposes only – final quantity and locations are determined on a project specific basis and in compliance with OPR SOW and approved by the OAFM Project Manager.







SUP-BST Bulk Storage

OS

Space Description

Scalable space required for the temporary storage of large items that will be distributed to the permanent location(s) within the tenant spaces such as paper, furniture, equipment, boxes, etc.

Wall Construction

Adjacencies

Construction

Walls:

Ceilings: NA Floors: NA Walls: NA STC Rating: NA

Doors

Door Type/Material: Door Size/Rating: Frame Type/Material: Hardware set:

Fixed Furnishings/Equipment

Casework: NA Specialties: NA Equipment: NA

Mechanical

HVAC: Part of multi-zoned HVAC system

NA

Air Pressure: NA

Plumbing: NA

Communications
Phone/Data Outlets:

Special Requirements: NA

Remarks

- Utilize open shelving products.
- · No exterior windows

Interior Finishes

Floors: Vinyl Composition Tile (VCT)

Base: 4" Rubber/Vinyl cove

Walls: PTD Gyp Bd Ceiling: ACT

Ceiling Height: 9'-0" Min.

Windows

Interior Frame Material: NA
Interior Frame Size: NA
Glazing: NA
Ext. Window Treatment: NA

Furniture

As indicated on floor plan.

Furniture layout for design purposes only – refer to furniture vendor for final quantity and design.

Electrical

Lighting: 35 foot-candles at 30" AFF, controlled

by occupancy sensors.


Power: Per plan in accordance with

local/state/federal code, whichever is

more stringent

^{*}Security requirements and layout for design purposes only – final quantity and locations are determined on a project specific basis and in compliance with OPR SOW and approved by the OAFM Project Manager.



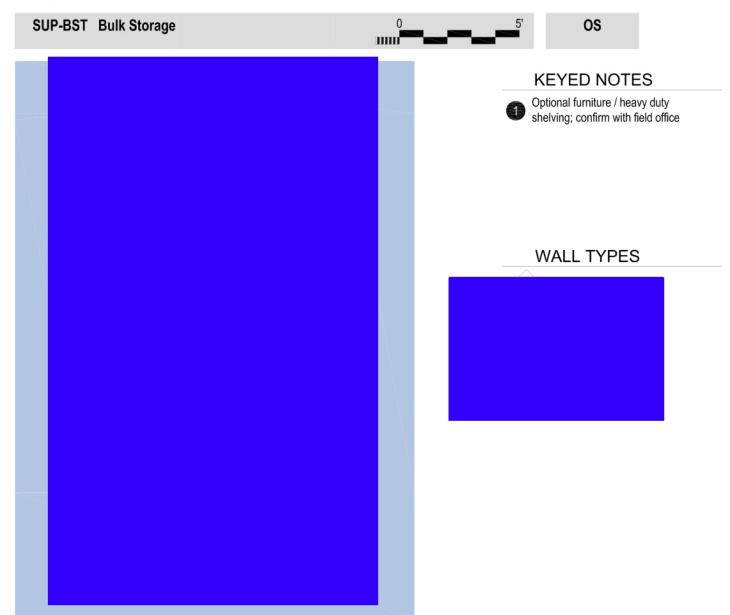



WS-S-64 Workstation (8' X 8')

Area: 64 Square Feet

os

Space Description

Systems furniture based space where one person works as dictated by the ICE Office and Workstation Standards. This may include free-standing furniture.

Wall Construction

Walls: NA

Adjacencies

Construction

Ceilings: NA Floors: NA Walls: NA STC Rating: NA

Doors

Door Type/Material: NA
Door Size/Rating: NA
Frame Type/Material: NA
Hardware set: NA

Fixed Furnishings/Equipment

Casework: NA Specialties: NA Equipment: NA

Mechanical

Plumbing:

HVAC: Part of multi-zoned HVAC system

Air Pressure: NA

Communications

Phone/Data Outlets:

Provide combination receptacles per plan

NA

Special Requirements: NA

Remarks

- Furniture procured and installed by ICE Furniture Vendor.
- ICE Furniture Vendor to provide power whips
- The Lessor shall provide power for 3-circuit/8 wire bottom-fed workstations, terminated in J-boxes.
- The Lessor shall connect workstation power whips to the appropriate junction boxes.
- The Lessor shall provide 90 degree liquid tight fitting at each feed location.
- Power poles are not preferred.

Interior Finishes

Floors: Open Office Area - CPT Tile

Base: Open Office Area - 4" Rubber/Vinyl cove

Walls: Open Office Area - PTD Gyp Bd

Ceiling: Open Office Area - ACT

Ceiling Height: 8'-6" Min.

Windows

Interior Frame Material: NA
Interior Frame Size: NA
Glazing: NA
Ext. Window Treatment: NA

Furniture

As indicated on floor plan

Furniture layout for design purposes only – refer to furniture vendor for final quantity and design.

Electrical

Lighting: 30-50 foot-candles at 30" AFF,

controlled by occupancy sensors arranged to control open office area.

Power: Per plan in accordance with


local/state/federal code, whichever is

more stringent

4-5 stations per 3-circuit/8 wire infeed (typ)

- Power preferred to be fed from adjacent wall or in under floor conduit.
- Voice/Data cabling and back-boxes provided and installed by Lessor or ICE OCIO.
- Receptacles, cover plates and final connections by Lessor or ICE OCIO.
- Refer to local/applicable codes for clear access width to access workstations in designed layout.
- Recommend 3" clear between wall and systems furniture.




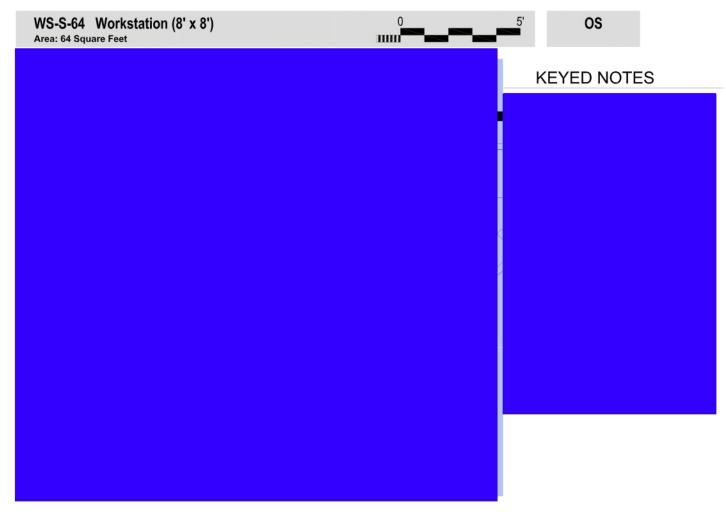

LEGEND

FW Junction Box with power whip



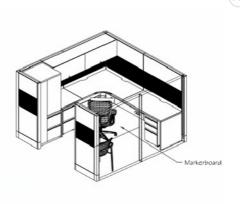

5-17

From: (b)(6); (b)(7)(C)

Sent: 3 Dec 2019 16:50:13 +0000

To: (b)(6); (b)(7)(C)

(b)(6); (b)(7)(C)

Subject: ERO Scarborough ME-PRO-13-ERO-0293- Meetings

Attachments: ERO Scarborough - Contact-List.pdf

Importance: High

Hello,

Was everyone invited by GSA for today's meeting at 2pm? If not please let me know.

Attached please find the project contact list for your reference.

Thank you,

(b)(6); (b)(7)(C)

MA. NCARB. SAME. Intl. Assoc. AIA.
OAFM Project Manager
Office of Asset and Facilities Management (OAFM)
FMD|OAFM|DHS|ICE

500 12th Street SW. (b)(6), (b)(7)(C)

Washington, DC 20536

O:305-597-(b)(6); C: 202-754^{(b)(7)(C)}

		Project Contact Lis	st		
Project Number	Address	40 Manson Libby Road			Date
PRO-13-ERO-0293	City, State Zip	Scarborough, Maine			12/3/2019
1110-13-2110-0233	FTE Count				12/0/2013
Dua wwa ma Offica		11	- Frankl	Diment	Oall
Program Office	Name	Title	Email	Direct	Cell
ERO	(b)(6); (b)(7)(C)	SDDO	(b)(6); (b)(7)(C)		
	-	Assistant Field Office Director			
OSD/Operations Support Division		Management Program Analyst			
(Mission Support)		Managoment Frogram Amaryot			
OPR- Security		Field Security Manager			
		Barrie Olivir ITEO Esta Barrie			
OCIO Cable/Wireless		Branch Chief - ITFO East Region			
	-	IT Service Support Section Chief New England Area Manager			
		Lead IT Specialist			
		IT Specialist			
		Cable/Wireless Design			
		Cable/Wireless Design			
		Sr. Network Engineer			
IT Field Operations Branch		Regional Deployment Lead, VTC Engineer			
		V1C Engineer		T	1
OCIO VTC Conference RM.			†		
CYB - CYBER CRIME CENTER	N/A				
Cyber Crime Center C3					
HSDN ROOM	N/A		<u> </u>		
TIODIV TIOOM	107				
TACCOM Eastern Region	(b)(6); (b)(7)(C)	Program Manager	(b)(6); (b)(7)(C)		
Antenna Comunications					
OOIO Phara Caratana		Coning Talanaman disable as Euripean			
OCIO Phone System		Senior Telecommunications Engineer IT Specialist			
		Tr openanot			
Contract Specialist DHS/ICE					
Furniture Imaging	-				
Furniture Installation					
GSA	(b)(6); (b)(7)(C)	Region 1			
		PM	(b)(6); (b)(7)(C)		
		Leassing Specialist			
		RPA Move			
Landlord					
Editatora					
Landlord's Architect					
Sign company					